SHEET TITLE:

SITE LAYOUT

L1.0



POLLINATOR PLANTING AREAS REFER TO PLANS TO BY LANARC REFER TO DETAIL REFER TO DETAIL-TBD 6" PVC PERFORATED PIPE REFER TO PLAN

DESCRIPTION

REFER TO DETAIL

6" DEPTH, REFER TO DETAIL

TYPE TBD, REFER TO PLANS BY

BOULDERS, TYPE TBD REFER TO PLAN AND DETAIL CONCRETE (FOR BENCH) REFER TO PLAN,STANDARD 4"

PLAYGROUND ENGINEERED WOOD FIBER MULCH 12" DEPTH MIN., REFER TO DETAIL 2,309

KEY NOTES

2 LOG STUMPS

1 BOULDERS, TYPE TBD

4 CONCRETE TUNNEL

7 HERITAGE 6' BENCH, MODEL #JPAB6

9 UAF-200 FLAT TOP FENCE, 4' HEIGHT

11 PLANTING AREA (DESIGNED BY LANARC)

8 6" PVC PERFORATED PIPE

(10) 4' GATE, TYPE TBD

LEGEND

6 4' MULCH TRAIL

3 9 FT SINGLE ZIG ZAG EMBANKMENT SLIDE, MODEL # PEL011

5 9 FT HIGH INSTITUTIONAL TEAM SWING, MODEL # PSWITSWSPB

ENGINEERED WOOD FIBER MULCH

14 GAUGE ROLL TOP STEEL EDGING BETWEEN TRAIL AND

MULCH

GRAVEL PLAY

PLANTING BEDS, AS SHOWN

TRAIL MULCH


GRAVEL PLAY

4' ENTRY GATE

- 1. ALL PLANTING SHOWN IS PROPOSED. PLANTING PLAN TO BE DESIGNED BY LANARC LANDSCAPE ARCHITECTURE.
- TURF TYPE TO BE DETERMINED. SQUARE FOOTAGE IS CALCULATED ON AREA WITHIN EXTENTS OF FENCING LIMITS.
- CONTRACTOR TO DETERMINE SLOPE OF HILL AND ADD FILL TO MEET SLOPE REQUIREMENTS OF EMBANKMENT SLIDE AS NECESSARY.

12.20.21

SHEET TITLE: DIMENSIONS LAYOUT

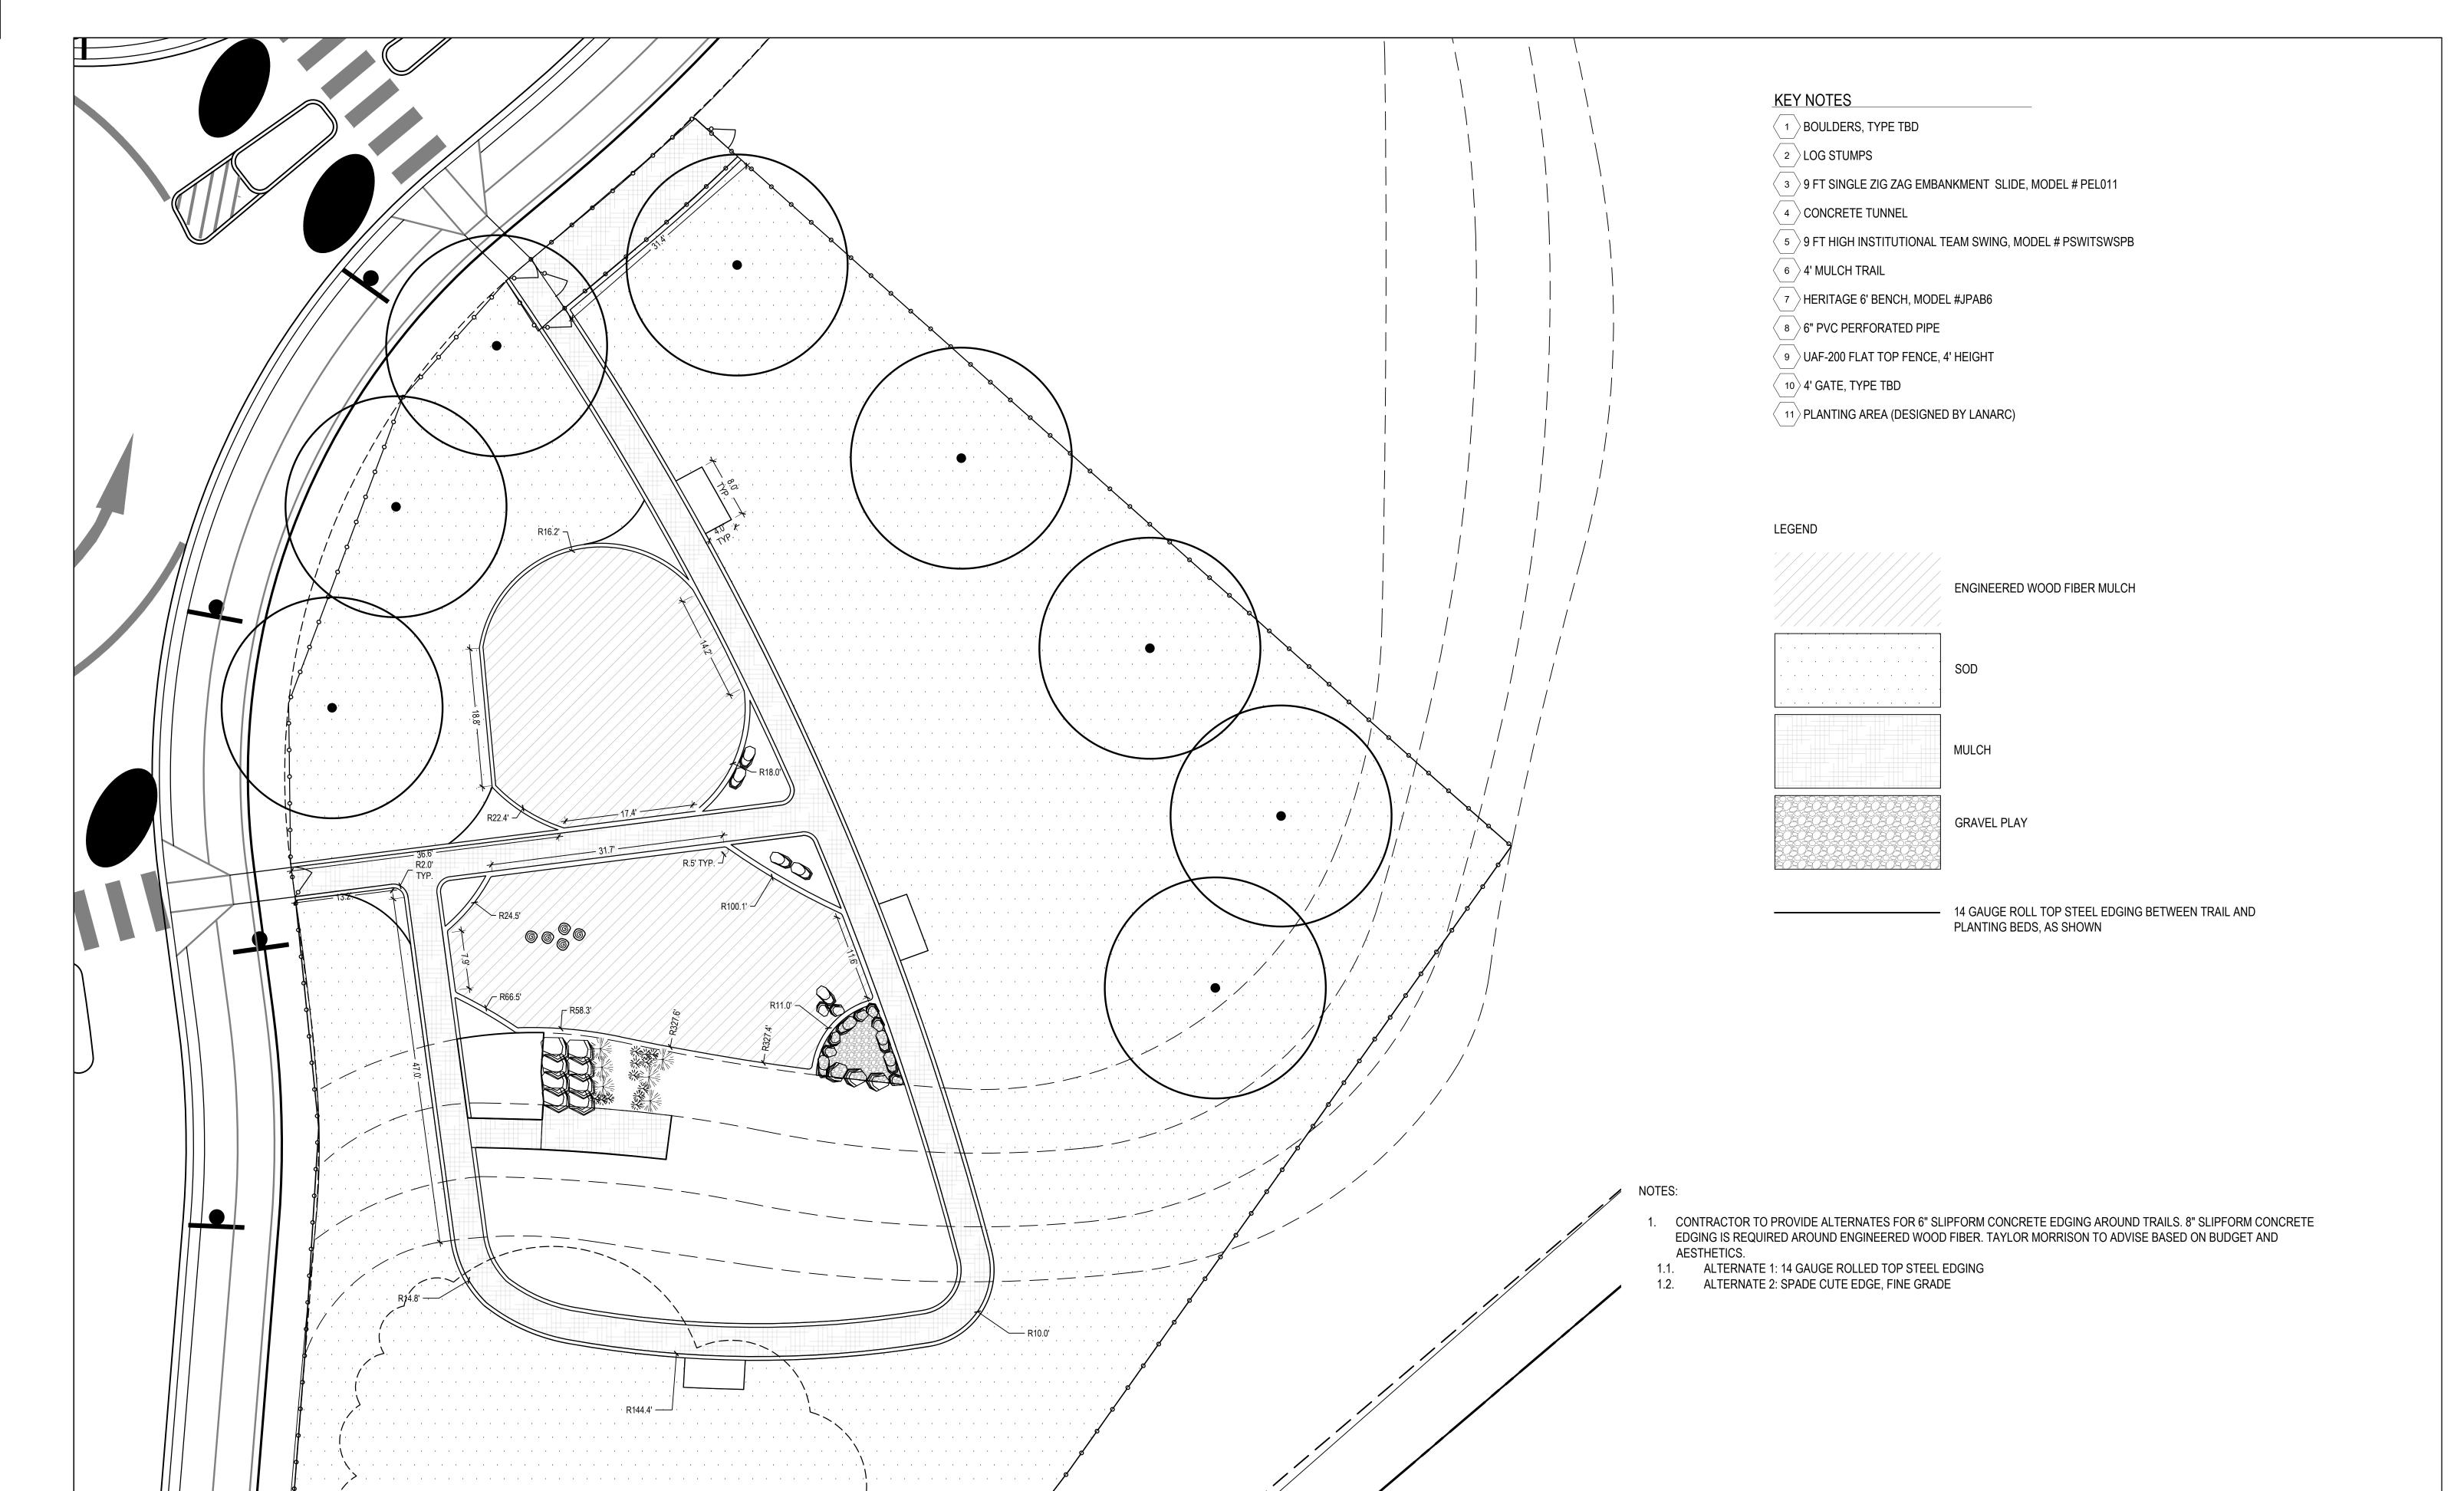




SHEET TITLE: DRAINAGE

LAYOUT

L1.2

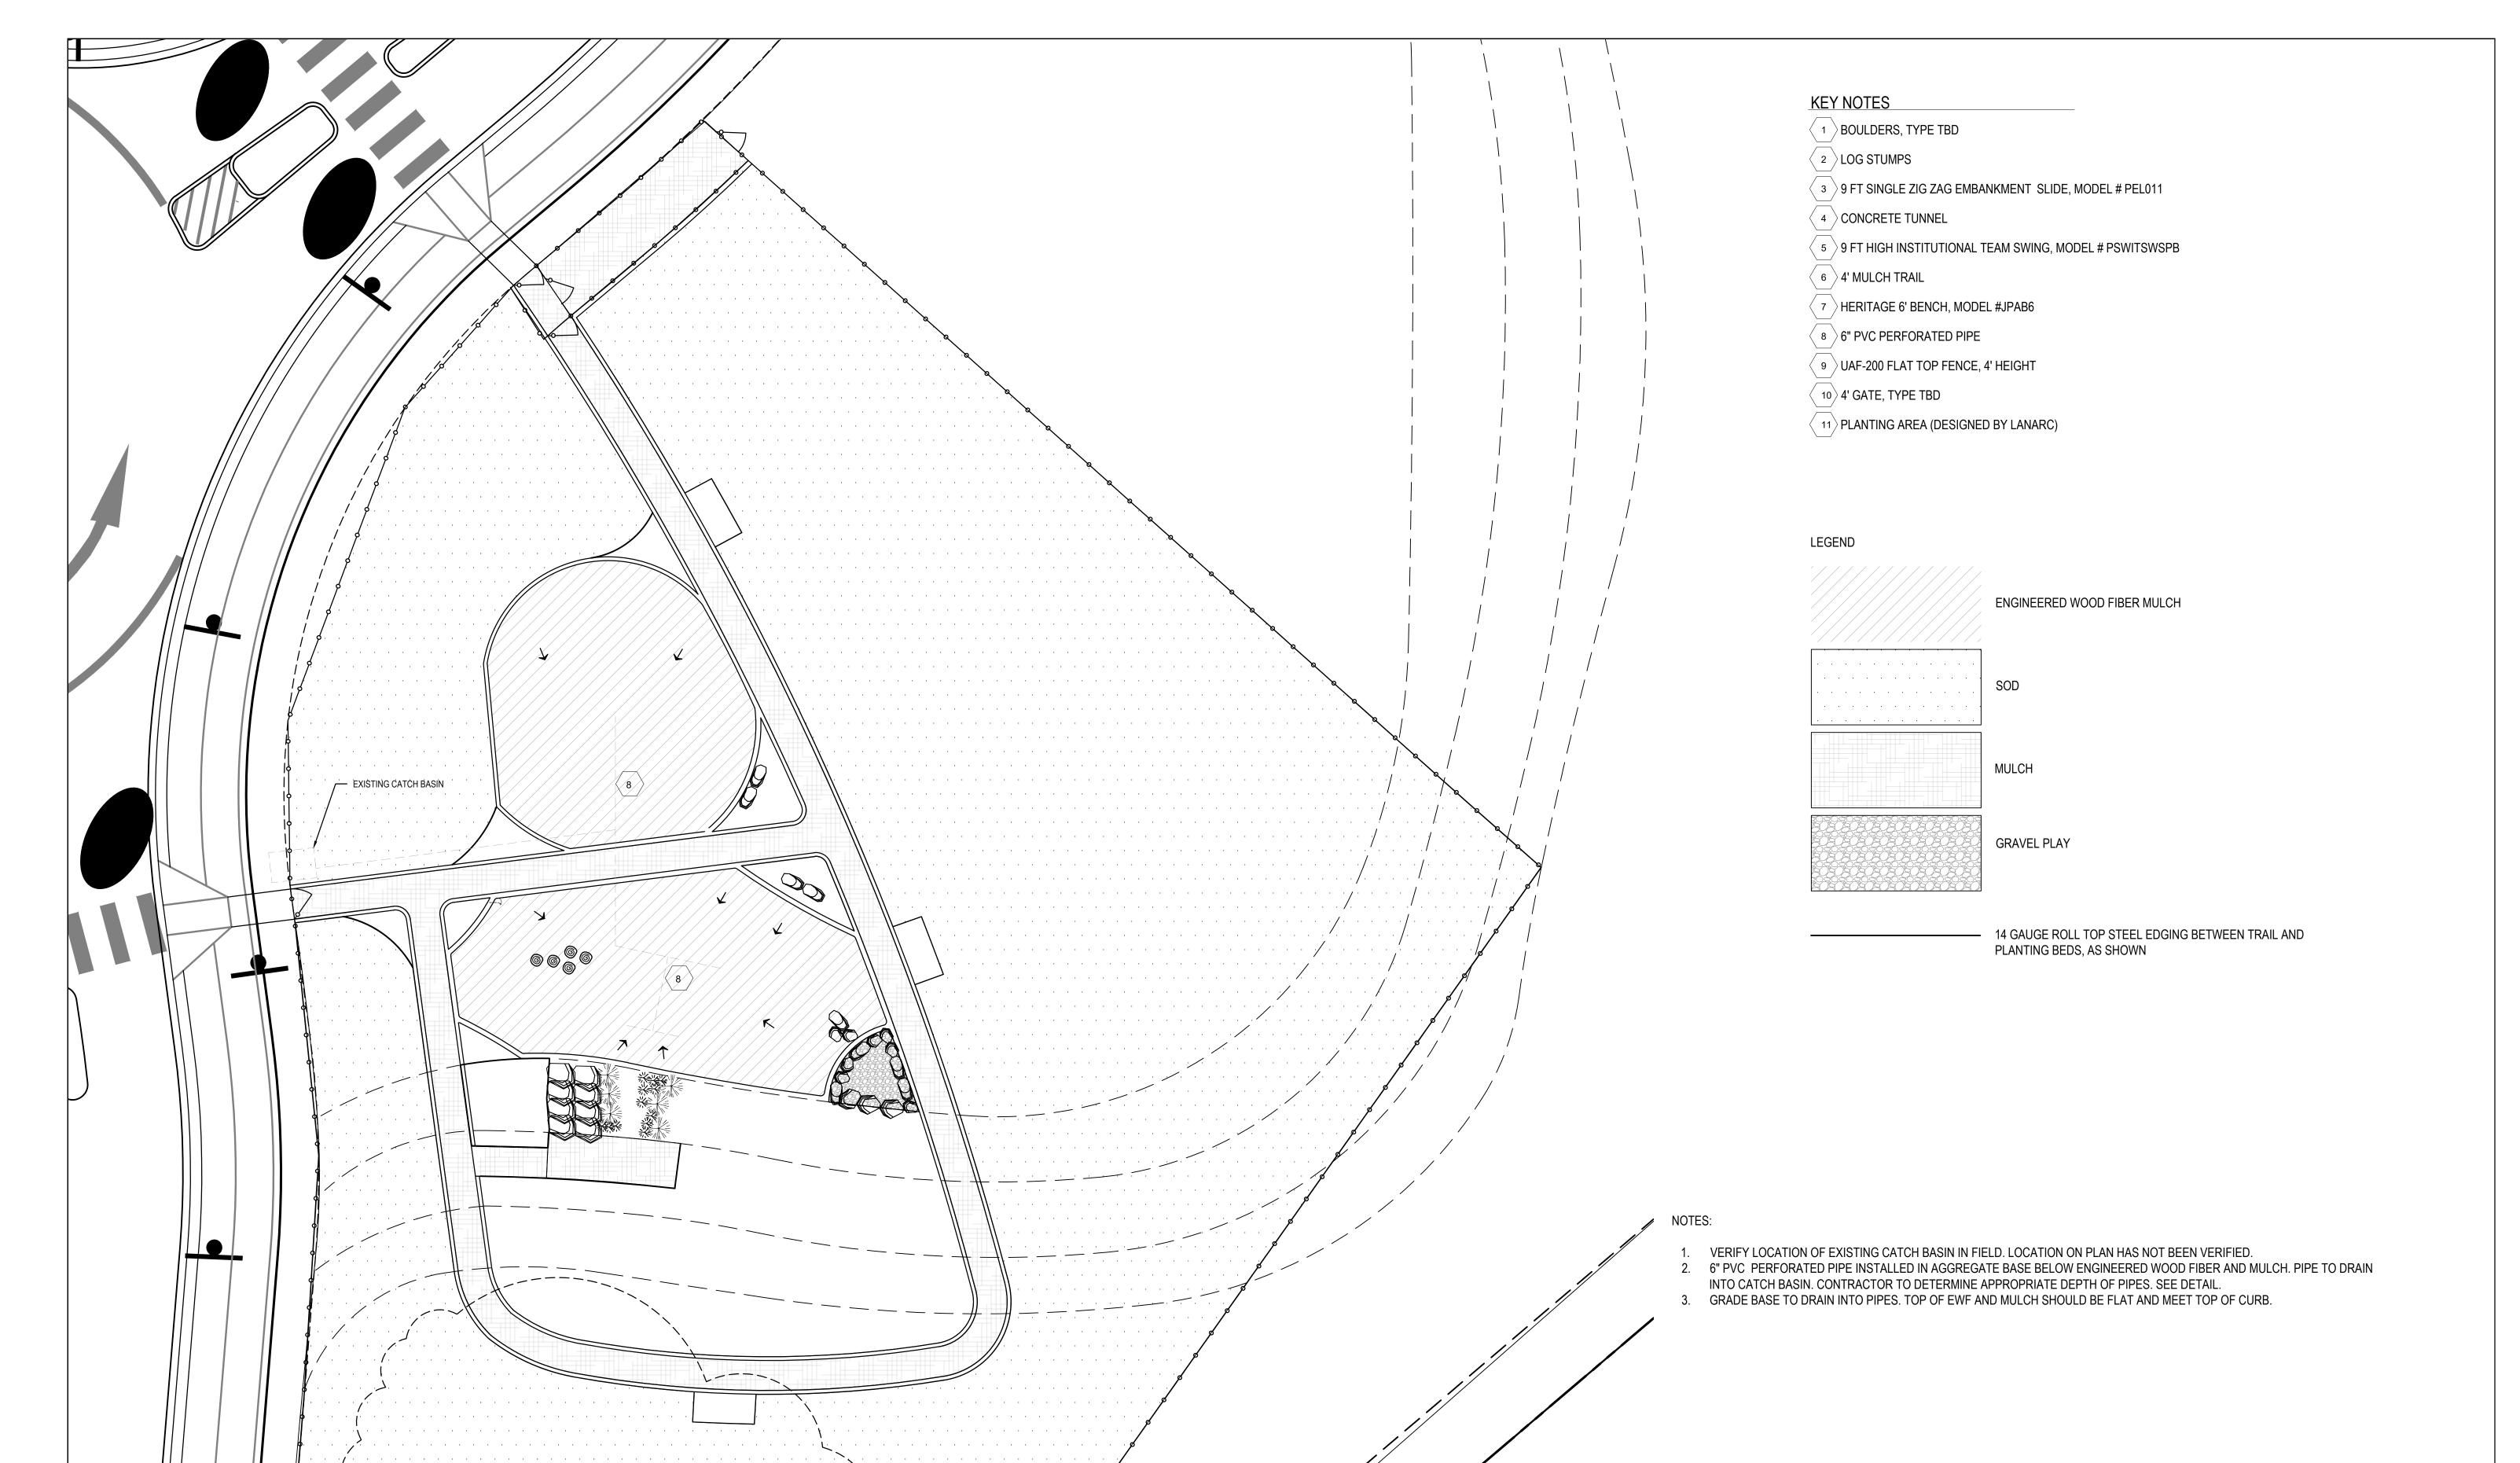





SHEET TITLE:

FENCE LAYOUT

L1.3

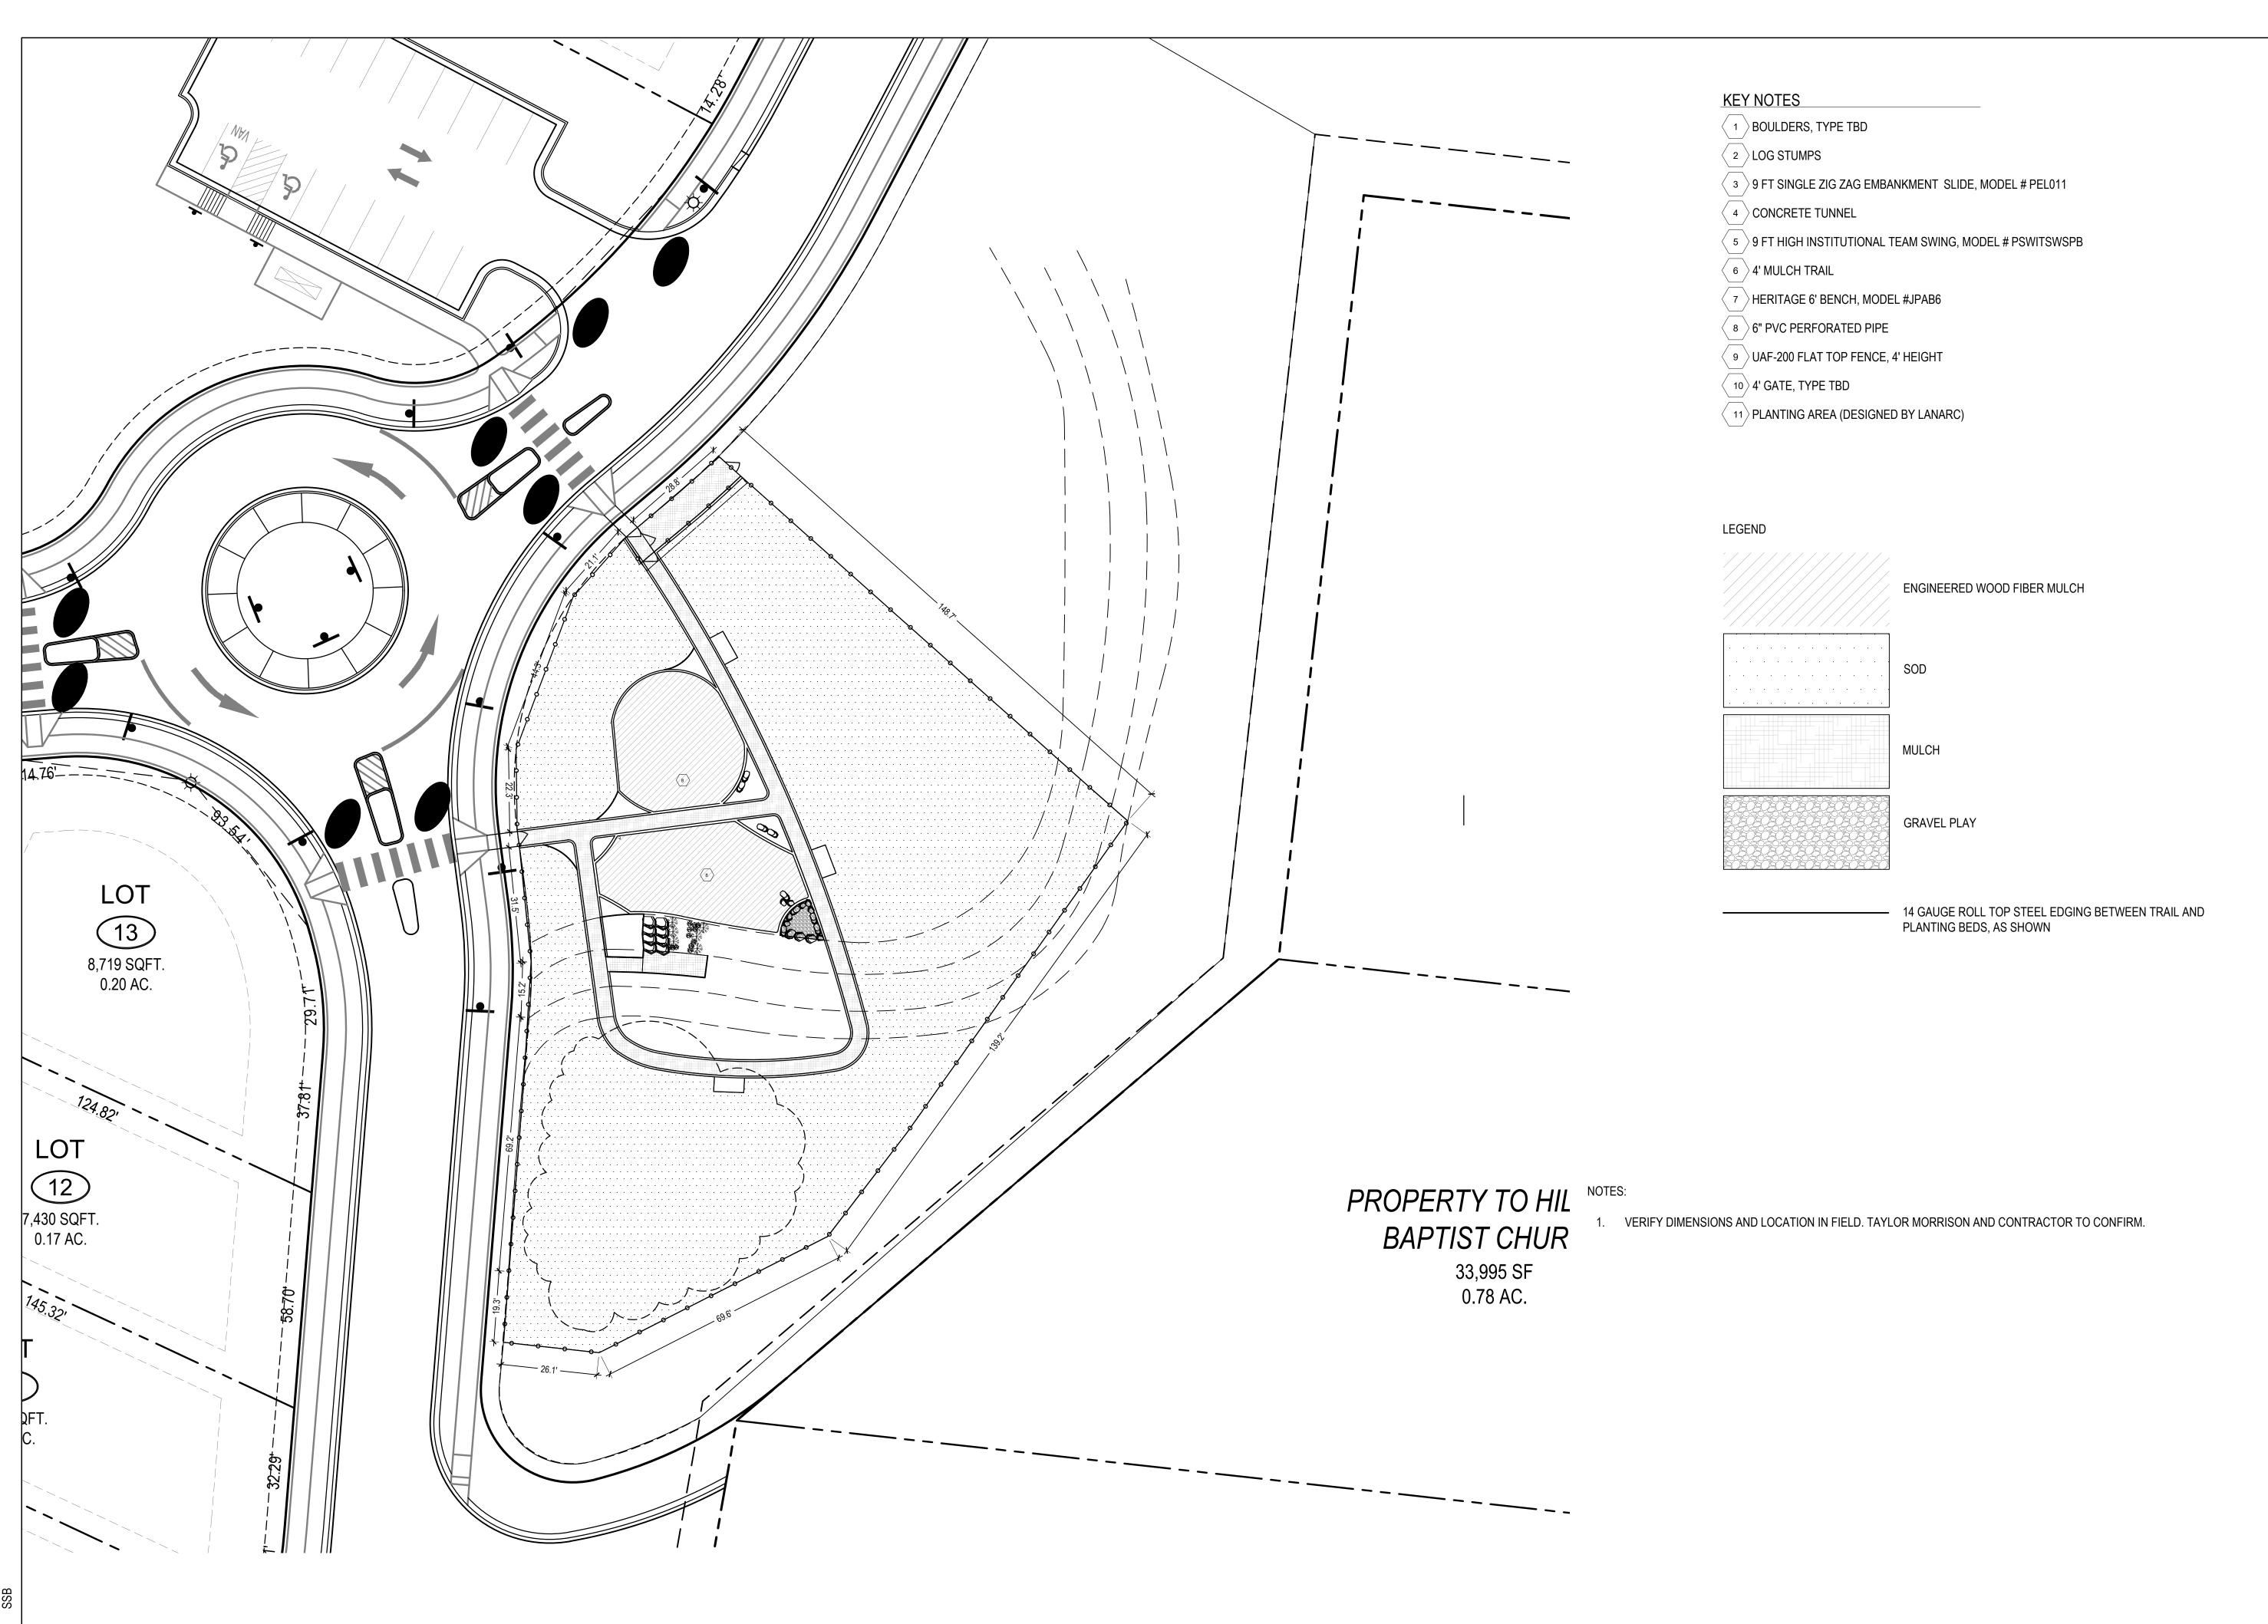

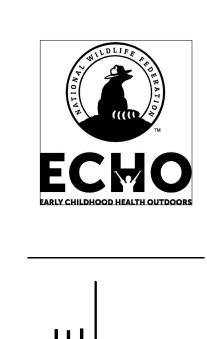

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OWNER:

TAYLOR MORRISON

2 ENGINEERED WOOD FIBER

3 CONCRETE

4 COMPACTED SUBGRADE

1. WET SET CONCRETE TUNNEL ON CONCRETE PAD. LET CONCRETE DRY COMPLETELY BEFORE COVERING WITH MULCH.

SCALE: 3/4" = 1'-0"

REFER TO SITE PLAN FOR LAYOUT.

54" CONCRETE TUNNEL

NOTES: INSTALL THIN LAYER OF MULCH ON FLOOR OF TUNNEL

VERTICAL SLIPFORM CURB - PLAYGROUND EDGE

REVEAL MAY VARY

SCALE: 1" = 1'-0"

VERTICAL "SLIP-FORMED" C.I.P CONCRETE CURBING

VERTICAL "SLIP-FORMED" C.I.P CONCRETE CURBING

3" LAYER COURSE WASHED

CONCRETE EDGE SHOWN FOR

VERIFY AND/OR SPECIFY

3. CONTRACTOR TO EXCAVATE

SLIPFORM CONCRETE DETAIL.

PLAYGROUND AREA TO FULL DEPTH OF PLAYGROUND

2. CONCRETE SUPPLIER TO

SURFACING.

BORDER.

AREAS SURROUNDING EWF

2 ENGINEERED WOOD FIBER PLAYGROUND SURFACING

GRAVEL, MIN. $\frac{3}{4}$ " DIAMETER. FILTER FABRIC ABOVE AND

4 COMPACTED SUBGRADE

BELOW.

5 4" MULCH

NOTES:

SLOPE SUBGRADE TOWARD

DRAIN, MIN. 2%

2 4" MULCH TRAIL

3 LANDSCAPE FABRIC

4 COMPACTED SUBGRADE

NOTES:

 CONCRETE EDGE SHOWN FOR MULCH TRAIL AND ADJACENT GRASS.

2. CONCRETE SUPPLIER TO VERIFY AND/OR SPECIFY SLIPFORM CONCRETE DETAIL.

EMBANKMENT SLIDE-STACKED STEPS

1) NATURAL CEDAR OR OTHER HARD WOOD.

SCALE: 1/2" = 1'-0"

(1) 6' EMBANKMENT SLIDE, BEYOND

② GRASSES, BEYOND BOULDER STEPS

(3) STACKED BOULDER STEPS

(4) 12" PLAYGROUND MULCH

5 COMPACTED SUBGRADE


1. STONE STEPS SHALL BE 6" MAX FROM

TOP OF STEP TO TOP OF STEP.

2 CHAMFER EDGE

SAND TOP AND ALL SIDES OF 3 SHARP POINTS OR ROUGHNESS. APPLY CLIMATE APPROPRIATE SEALANT.

4 SURFACING

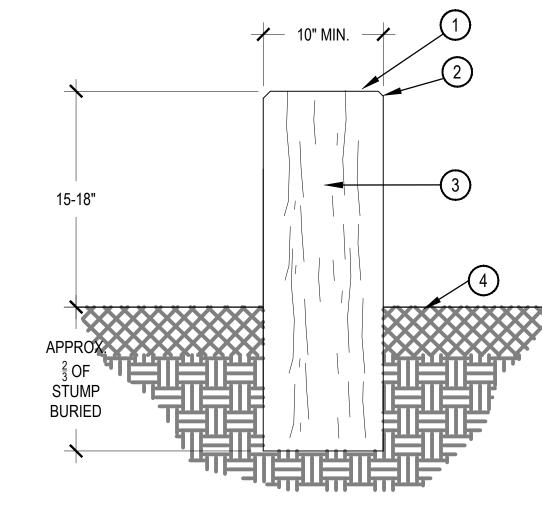

VERTICAL SLIPFORM CURB

 $\frac{3}{4}$ " RADIUS

 $\frac{3}{4}$ " RADIUS

SCALE: 1" = 1'-0" 1 6" PEA GRAVEL DIGGING MEDIA

2 2" COMPACTED ABC

3 GEOTEXTILE FABRIC

4 COMPACTED SUBGRADE

5 24-36" BOULDER SET BELOW FINISH GRADE

SCALE: 1/2" = 1'-0"

6 CRUSHER FINES OR MULCH

VARIES, SEE PLAN **INSTALLATION NOTES:**

1. LAY COMMERCIAL LANDSCAPE FABRIC. 2. SPREAD MULCH EVENLY, SMOOTH OVER HIGH OR LOW SPOTS. 3. CROSS-SLOPE TRAIL AT 1-2% WITH

GRADE WHERE TOPOGRAPHY DICTATES.

LOG SEAT STUMP DETAIL

SCALE: 1-1/2" = 1'-0"

1 SHREDDED CEDAR MULCH

2 SLOPE ADJACENT GRADE AWAY

3 LANDSCAPE FABRIC

4 COMPACTED SUBGRADE

5 PLANTED EDGE

6 ROLLED TOP STEEL EDGER OR SIMILAR

MULCH DETAIL

GRAVEL PLAY PIT WITH BOULDER EDGE

SCALE: 3/4" = 1'-0"

DETAILS

SHEET TITLE:

DATE:

12.20.21 <u>01.31.22</u>

L2.0



BRIGHTON

SHEET TITLE:

DETAILS

REV. DESCRIPTION
A RELEASE TO PRODUCTION BY DATE CHKD BY

JWW 7/14/2006 JRS KAY PARK REC. CORP. 1301 Pine St. P.O. Box 477 Janesville, IA 50647-0477 69 11/16" 2 X 4 SLATS ARE RECYCLED PLASTIC
BASES ARE ZINC PLATED
ALL HOLES PRE-DRILLED AND
ALL HARDWARE IS ZINK PLATED
UNIT WEIGHT APPROX. 140 LBS.


JOB NUM

JOB NUM JOB NUMBER STANDARD HERITAGE 6' BENCH JPABG UNLESS OTHERWISE SPECIFIED
DIMENSIONS ARE IN INCHES
TOLERANCES:
DECIMAL FRACTION OVERALL
XX±.03 ±1/16 120±3/8
.XXX±.005 >120±1 ASSEMBLY NUMBER SCALE

- 3:32

DRAWING NO.
PB 6____HER-SPEC PB 6___HER SHEET TOF 1 A

HERITAGE 6' BENCH

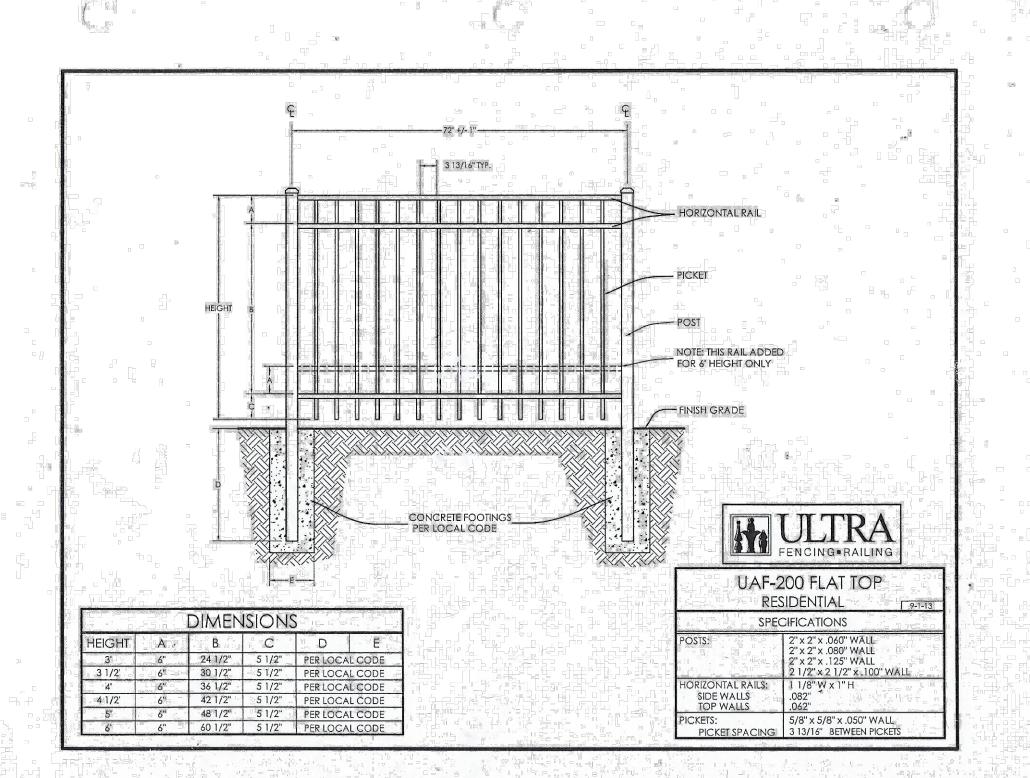

9 UAF-200 FLAT TOP RESIDENTIAL SERIES FENCING