
# **CONSTRUCTION DRAWINGS FOR:**

# ECHO Park At Riverstone

# Missouri City, Texas

# Sitework / Planting / Irrigation

### **VICINITY MAP**

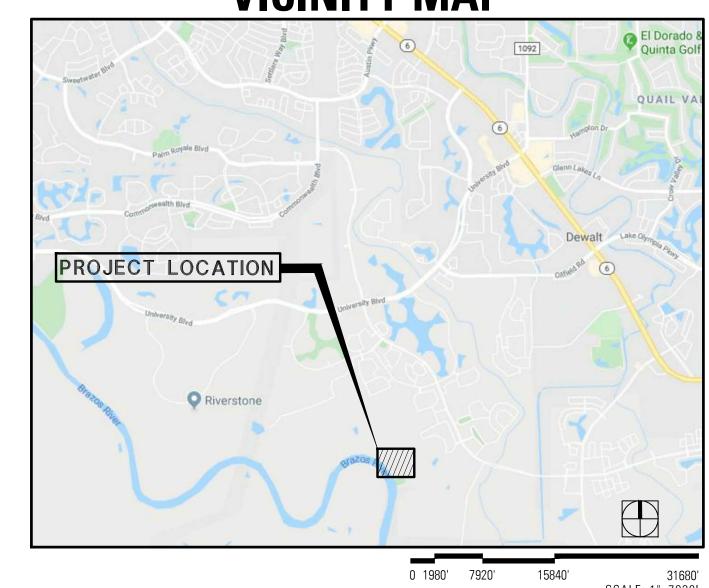

#### **OWNER: TAYLOR MORRISON**

**CONTACT**: Bobby Skinner 5353 W. Sam Houston Pkwy N. Suite 190 Houston, Texas 77041 0: 281/598-3035

### **IRRIGATION DESIGNER: James Pole Irrigation Consultants**

CONTACT: James Pole 100 North Locust Street, Suite 3 Denton, Texas 76201 0: 940/ 243-2364 F: 940/ 382-2475

### **LANDSCAPE ARCHITECT: TBG Partners**

CONTACT: Meade Mitchell 1333 W Loop S Suite 1450 Houston, Texas 77027 0: 713/439-0027 F: 713/439-0067

CONTACT: John Haas 4522 Owens Creek Lane Spring, Texas 77388 0: 281/ 433-5007

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cover sheet

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echo park at

riverstone

**Taylor Morrison** 


H20378

issue date

June 2, 2021

drawn: AW ES MF reviewed: JZ MM

LC 1.0

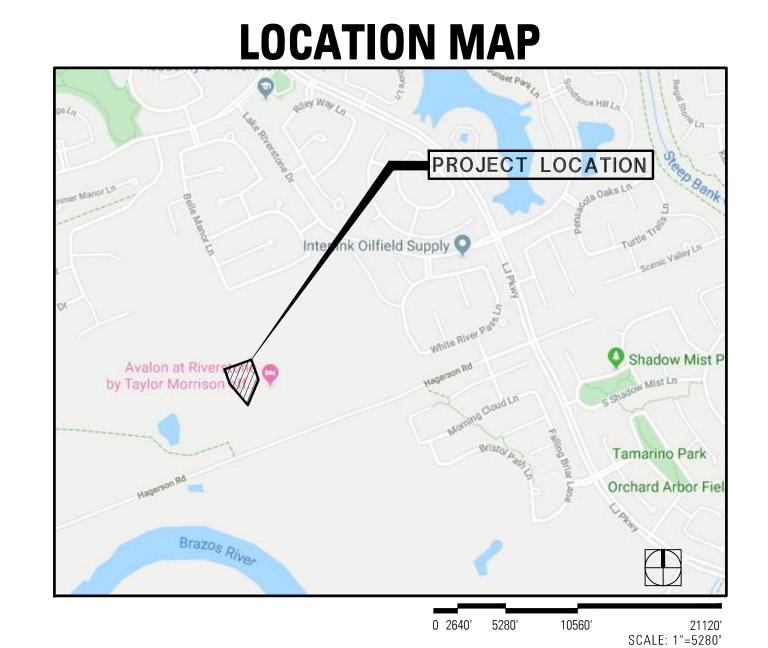

**A PROJECT BY** 

### **STRUCTURAL ENGINEER:** HASKI, LLC.

#### **GENERAL SITEWORK NOTES:**

- 1.) CONTRACTOR SHALL BE FAMILIAR WITH EXISTING SITE CONDITIONS AND UNDERGROUND UTILITIES, PIPES AND STRUCTURES. CONTRACTOR SHALL TAKE SOLE RESPONSIBILITY OF ANY COST INCURRED DUE TO BODILY INJURY AND/OR DAMAGE OF OWNER'S PROPERTY OR SAID UTILITIES. CONTRACTOR IS RESPONSIBLE FOR CONTACTING UTILITY COMPANIES BEFORE EXCAVATION.
- 2.) ANY CONFLICTING INFORMATION SHALL BE BROUGHT TO THE ATTENTION OF THE LANDSCAPE ARCHITECT OR THE LANDSCAPE ARCHITECT AND OWNER SHALL ASSUME THE CONTRACTOR HAS INCORPORATED THE MOST COSTLY ITEM
- 3.) DO NOT WILLFULLY PROCEED WITH CONSTRUCTION AS DESIGNED WHEN UNKNOWN OBSTRUCTIONS OR GRADE DIFFERENCES EXIST THAT MAY HAVE NOT BEEN KNOWN DURING DESIGN. SUCH CONDITIONS SHALL BE IMMEDIATELY BROUGHT TO THE ATTENTION OF THE LANDSCAPE ARCHITECT. THE CONTRACTOR SHALL ASSUME FULL RESPONSIBILITY FOR ALL NECESSARY REVISIONS DUE TO FAILURE TO GIVE SUCH NOTIFICATION.
- 4.) CONTRACTOR SHALL BE RESPONSIBLE FOR ALL COORDINATION WITH SUBCONTRACTORS TO ACCOMPLISH SCOPE OF WORK. CONTRACTOR SHALL COORDINATE CONSTRUCTION WITH OTHER TRADES WORKING ON THE SITE SIMULTANEOUSLY.
- 5.) CONTRACTOR IS RESPONSIBLE FOR LOCATING AND PROTECTING EXISTING IRRIGATION AND LANDSCAPE ON SITE FROM AN DAMAGE. CONTRACTOR SHALL NOTIFY LANDSCAPE ARCHITECT OF ANY CONFLICTS IMMEDIATELY.
- 6.) CONTRACTOR SHALL NOTIFY OWNER AND LANDSCAPE ARCHITECT 48 HOURS PRIOR TO COMMENCEMENT OF WORK TO COORDINATE PROJECT INSPECTION SCHEDULES.
- 7.) THE CONTRACTOR SHALL BE RESPONSIBLE FOR FIELD VERIFICATION OF EXISTING CONDITIONS, AND SHALL PERFORM FIELD MEASUREMENTS PRIOR TO FABRICATION AND/OR PURCHASE OF ANY MATERIAL AND SHALL CONTACT THE LANDSCAPE ARCHITECT SHOULD EXISTING CONDITIONS BE DIFFERENT FROM THE DESIGN DRAWINGS FOR THIS PROJECT. CONFLICTS ARISING DUE TO LACK OF COORDINATION SHALL BE THE RESPONSIBILITY AND THE EXPENSE OF THE CONTRACTOR.
- 8.) ANY REQUIRED CHANGES TO THE DRAWINGS RESULTING FROM THE ACCEPTANCE OF CONTRACTOR'S ALTERNATES AND/OR SUBSTITUTIONS ARE THE RESPONSIBILITY OF THE CONTRACTOR AND SHALL BE SUBMITTED TO THE LANDSCAPE ARCHITECT AND THE OWNER FOR APPROVAL.
- 9.) THE CONTRACTOR SHALL COORDINATE STORING OF MATERIALS, PARKING OF VEHICLES AND RESTRICTIONS OF WORK WITH THE OWNER. UNDER NO CIRCUMSTANCES SHALL ANY CONTRACTOR STORE MATERIALS OR PARK VEHICLES UNDER THE CANOPY OF EXISTING TREES.
- 10.) CONTRACTOR SHALL COMPLY WITH ALL APPLICABLE ORDINANCES AND LOCAL CODES. REQUIRED PERMITS SHALL BE OBTAINED BY THE CONTRACTOR.
- 11.) CONTRACTOR SHALL PROVIDE UNIT PRICES BASED ON QUANTITIES ON DOCUMENTS. FIELD CONDITIONS MAY REVISE ACTUAL LOCATION, INCREASING OR DECREASING THE EXTENT OF WORK BID. CHANGES TO THE EXTENT OF WORK RESULTING IN AN INCREASE WILL BE BASED ON UNIT PRICES AND PERFORMED SUBJECT TO APPROVAL OF THE LANDSCAPE ARCHITECT AND THE OWNER IN THE FORM OF A CHANGE ORDER.
- 12.) ALL CONSTRUCTION COVERED BY THESES CONTRACT DOCUMENTS SHALL BE IN CONFORMANCE WITH THE LATEST EDITION OF ALL APPLICABLE CITY AND OSHA CODES AND STANDARDS INCLUDING BUT NOT LIMITED TO THE SOUTHERN BUILDING CODE, ENACTED BY THE INTERNATIONAL CONFERENCE OF BUILDING OFFICIALS, MOST RECENT EDITIONS AND AMENDMENTS AS ADOPTED BY THE LOCAL GOVERNMENT.
- 13.) THE CONTRACTOR SHALL PROVIDE ALL LABOR, MATERIALS AND SUPERVISION NECESSARY TO ACCOMPLISH THE WORK AS SHOWN AND NOTED ON THE DRAWINGS UNLESS OTHERWISE SPECIFIED.
- 14.) CONTRACTOR IS RESPONSIBLE FOR PROVIDING AND SERVICING TEMPORARY TOILET FACILITIES.
- 15.) CONTRACTORS AND SUBCONTRACTORS ARE RESPONSIBLE FOR REMOVAL OF TRASH AND REPAIR OF HAZARDOUS CONDITIONS (TOOL, OPEN HOLES, ETC.) ON A DAILY BASIS BY END OF WORK DAY. REMOVE ALL EXCESSIVE DIRT BUILD UP ON HAUL ROUTE AS REQUIRED DAILY AND BY NOON EVERY FRIDAY.
- 16.) WEEKEND WORK PERMISSIBLE WITH DRY WEATHER CONDITIONS AND WITH PROVISIONS FOR STREET CLEANING AT THE END OF THE WORK DAY.
- 17.) UPON COMPLETION OF CONSTRUCTION AND PRIOR TO FINAL APPROVAL, CONTRACTOR SHALL THOROUGHLY CLEAN UP THE PROJECT SITE OF ALL TRASH, SCRAP, BRICK PIECES, MORTAR AND LITTER, ETC. REPAIR ALL DAMAGE TO FINISH GRADE INCLUDING TAILINGS FORM EXCAVATIONS, WHEEL RUTS, ETC., CAUSED BY CONSTRUCTION.

### CONSTRUCTION MANAGEMENT PRACTICES For WETLAND AREAS

#### GOALS:


RIVERSTONE DEVELOPMENT COMPANY HAS PREPARED AND ADOPTED A POLICY PERTAINING TO ITS PROJECTS' CONSTRUCTION ACTIVITIES THAT WILL TAKE PLACE IN AND AROUND AREAS THAT ARE, OR MAY BE, CLASSIFIED AS JURISDICTIONAL WATERS OF THE UNITED STATES, INCLUDING WETLANDS.

IT IS THE POLICY OF RIVERSTONE DEVELOPMENT COMPANY TO PREVENT ADVERSE IMPACT, INTENTIONAL OR INCIDENTAL, TO SENSITIVE AQUATIC ENVIRONMENTS THAT MAY BE REGULATED BY THE CLEAN WATER ACT OR THE RIVERS AND HARBOURS ACT. THE PURPOSE OF THIS POLICY IS TO PROVIDE A SET OF MANAGEMENT PRACTICES AND INSTRUCTIONS TO CONTRACTORS ON THE PROPER WAY OF PERFORMING CONSTRUCTION ACTIVITIES IN AND AROUND JURISDICTIONAL AREAS.

IT IS THE RESPONSIBILITY OF ANY PERSON OR COMPANY, INCLUDING THEIR SUBCONTRACTORS, WHO ARE UNDER CONTRACT TO RIVERSTONE DEVELOPMENT COMPANY, TO ABIDE BY THIS POLICY.

#### **MANAGEMENT PRACTICES:**

- 1.) ALL CONSTRUCTION ACTIVITIES WILL BE RESTRICTED TO PERMITTED AREAS ONLY. IF THE NATURE OF THE PROJECT IS SUCH THAT THE WORK AREA IS PARCELED OUT OF A LARGER WETLAND AREA, THE WORK WILL BE RESTRICTED TO THE PARCEL ONLY, UNLESS SPECIAL ARRANGEMENTS HAVE BEEN MADE IN COORDINATION WITH AN AUTHORIZED COMPANY REPRESENTATIVE.
- 2.) NON-PERMITTED WETLAND AREAS WILL BE CORDONED OFF BY CONSTRUCTION FENCING OR OTHER SUITABLE BARRIERS. THE LIMITS OF THE PERMITTED WORK AREA WILL BE VISIBLY MARKED BY STAKES, FLAGS, OR OTHER SUITABLE MARKERS.
- 3.) FOR WORK PERFORMED IN UPLANDS WITHIN 50 FEET OF A WETLAND BOUNDARY (100 FEET IF THE WETLAND IS LOCATED DOWN GRADIENT FROM THE PROJECT AREA), A SILT FENCE OR OTHER SUITABLE PARTICULATE FILTER SYSTEM WILL BE PLACED ALONG THE LENGTH OF THE PROJECT SITE, AS NEAR TO THE PROJECT SITE AS POSSIBLE.
- 4.) INGRESS AND EGRESS FOR WORK IN OR ACROSS WETLANDS WILL BE BY PERMITTED TEMPORARY ACCESS ROADS, OR BY WOODEN CONSTRUCTION MATS. AN AUTHORIZED COMPANY REPRESENTATIVE MUST BE NOTIFIED PRIOR TO THE PLACEMENT OR CONSTRUCTION OF ANY ACCESS ROAD.
- 5.) TEMPORARY ROADS THROUGH WETLANDS WILL BE LIMITED TO THE MINIMUM SURFACE AREA REQUIRED TO PERFORM THE WORK AND WILL BE REMOVED AS SOON AS POSSIBLE AFTER WORK IS COMPLETED. ALL STRUCTURAL MATERIALS ARE TO BE REMOVED FROM THE WETLAND AREA.
- 6.) WOODEN MATS MUST BE LIMITED TO THE MINIMUM SURFACE AREA REQUIRED TO PERFORM THE WORK, AND WILL BE REMOVED AS SOON AS POSSIBLE AFTER WORK IS COMPLETED. NO SAND, GRAVEL, SOIL, OR OTHER SUB-BASE IS PERMITTED.
- 7.) IN EVERY LOCATION WHERE A TEMPORARY ROAD CROSSES A WETLAND, THE ORIGINAL BOTTOM CONTOUR OF THE WETLAND AREA MUST BE RESTORED ONCE THE WORK HAS BEEN COMPLETED.
- 8.) EXCAVATED MATERIALS MAY BE MOVED OR PLACED WITHIN THE PERMITTED WORK AREA. HOWEVER, SUCH MATERIALS MAY NOT BE PLACED OR STORED IN ADJACENT OR SURROUNDING WETLANDS.
- 9.) DOWNSTREAM OR ADJACENT JURISDICTIONAL AREAS MUST BE PROTECTED FROM PARTICULATE MATTER THAT MAY BE PLACED BY A HYDROLOGIC EVENT. SILT FENCES, HAY BALES, OR OTHER SUITABLE FILTER SYSTEMS WILL BE PLACED AS NEAR TO THE WORK AREA AS POSSIBLE, UP TO AND INCLUDING THE ENTIRE PERIMETER OF THE WORK AREA. SUCH MEASURES WILL BE TAKEN PRIOR TO COMMENCING CONSTRUCTION, AND WILL BE COORDINATED WITH AN AUTHORIZED COMPANY REPRESENTATIVE.
- 10.) ANY FILL MATERIALS WHICH ARE TO BE PLACED WITHIN THE PERMITTED WORK AREA MUST BE DELIVERED DIRECTLY TO THE WORK AREA. SUCH MATERIALS MAY NOT BE STOCKPILED OR TEMPORARILY STORED IN ADJACENT OR SURROUNDING WETLANDS.
- 11.) EQUIPMENT STAGING AREAS AND MATERIALS STORAGE AREAS ARE TO BE LOCATED OUTSIDE THE PERMITTED WORK AREA, AND MAY NOT BE LOCATED IN ADJACENT OR SURROUNDING WETLANDS.
- 12.) ANY VEGETATION WHICH IS REMOVED OR CLEARED FROM THE PERMITTED WORK AREA MAY NOT BE PLACED IN ADJACENT OR SURROUNDING WETLANDS. BRUSH OR VEGETATION DEBRIS MAY BE CHIPPED IN PLACE, OR BURNED IN ACCORDANCE WITH APPLICABLE LAWS AND ORDINANCES, AS LONG AS NO RESIDUAL MATERIALS FALLS OUTSIDE THE PERMITTED WORK AREA AND INTO A WETLAND.

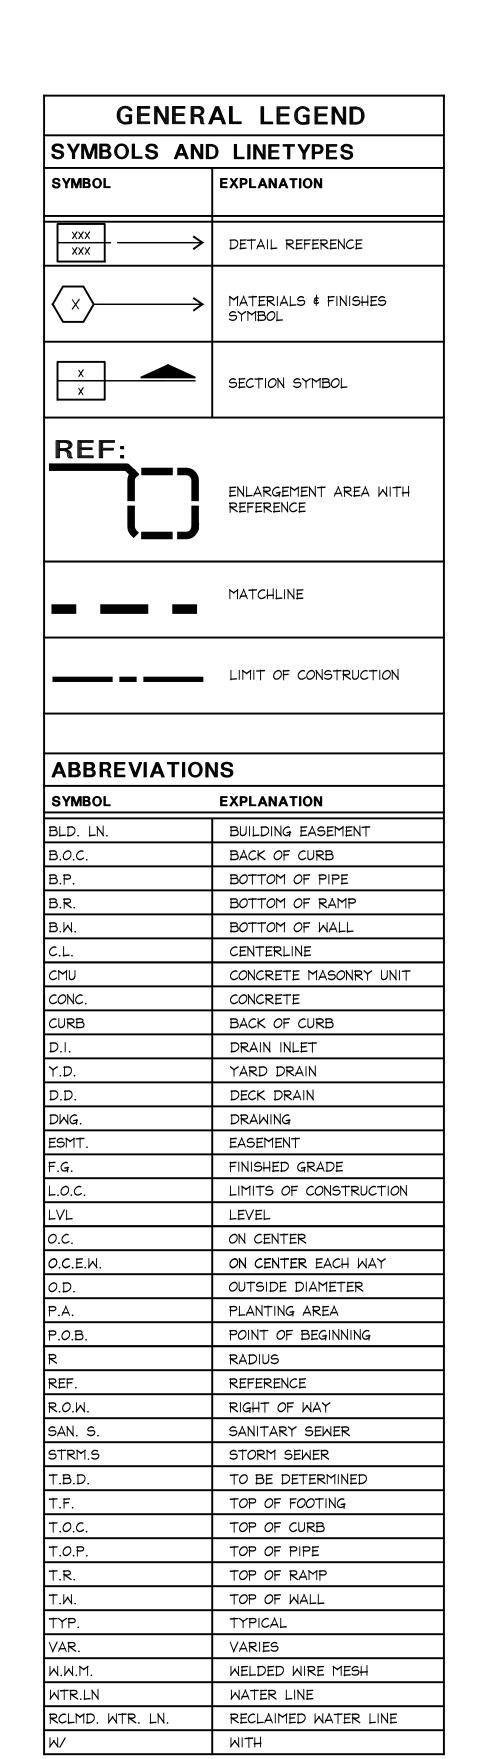



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project

# echo park at riverstone

Taylor Morrison Missouri City, Texas

project number H20378

issue date June 2, 2021

designed: AW JS drawn: AW ES MF reviewed: JZ MM

sheet title

### general notes & legend

C 1.1

KEY	DESCRIPTION /MODEL NUMBER	COLOR	FINISH	CONTACT	REMARKS
CONCI	RETE				
(C.1)	STANDARD CONCRETE	GRAY	MEDIUM BROOM FINISH - PERPENDICULAR TO DIRECTION OF WALK	LOCAL SOURCE	CONTRACTOR TO SUBMIT SHOP DRAWINGS AND SAMPLE PRIOR TO CONSTRUCTION FOR L.A. APPROVAL.
(C.2)	INTEGRAL COLOR CONCRETE	DESERT SAND C-11	TOP CAST SURFACE RETARDER 1/8"-3/8" 50 CANARY GREEN	COMPANY: LM SCOFIELD PHONE: (972) 839-3730 CONTACT: JESSE GULLEDGE	CONTRACTOR TO SUBMIT 5'X5' MOCKUP FOR INSPECTION
(C.3)	INTEGRAL COLOR CONCRETE	C-27 WESTWOOD BROWN	BOARDWALK STAMPED	COMPANY: LM SCOFIELD PHONE: (972) 839-3730 CONTACT: JESSE GULLEDGE	CONTRACTOR TO SUBMIT 5'X5' MOCKUP FOR INSPECTION
(C.4)	SEEDED CONCRETE				
DRAIN	AGE				
(D.1)	8" SDR35 SOLID PIPE	PURPLE	N/A	CONTACT: NDS PHONE: 1-800-726-1994	REF. SPECS FOR SUBMITTAL REQ'S.
(D.2)	6" SDR35 HARD PERFORATED PIPE W/ NON-WOVEN GEOTEXTILE FABRIC SOCK	PURPLE	N/A	CONTACT: NDS PHONE: 1-800-726-1994	REF. SPECS FOR SUBMITTAL REQ'S.
(D.3)	12" SQ. GRATE/DRAIN (NDS#1211) W/ CATCH BASIN (NDS#1200NGB)	BLACK	N/A	CONTACT: NDS PHONE: 1-800-726-1994	REF. SPECS FOR SUBMITTAL REQ'S.
(D.4)	6" ATRIUM GRATE (NDS#90)	BLACK	N/A	CONTACT: NDS PHONE: 1-800-726-1994	REF. SPECS FOR SUBMITTAL REQ'S.
PLAY	EQUIPMENT				
(E.1)	PLAY TOWER ROBINIA CLIMBING FRAME NO.17 PRODUCT CODE CF.2.17	ROBINIA	ROBINIA	CONTACT: Sean Procyk DUNCAN \$ GROVE LTD OFFICE: 1 888 571 9470 CELL: 1 403 431 0441 WEB: DUNCANANDGROVE.COM	CONTRACTOR TO PROVIDE CUT SHEET TO LANDSCAPE ARCHITECT PRIOR TO ORDERING, STAKE LOCATION IN FIELD FOR LOCATION
(E.2)	COLUMBIA CASCADE EMBANKMENT SLIDE - 8' ELEVATION DROP, CURVED - MODEL NO: 1650-83-01-EMB	CHUTE: TAN  METAL: TBD FROM  MANUFACTURER'S  STANDARD RANGE	N/A	CONTACT: ERIC HILLER / COLUMBIA CASCADE PHONE:	CONTRACTOR TO PROVIDE CUT SHEET TO LANDSCAPE ARCHITECT PRIOR TO ORDERING, STAKE LOCATION IN FIELD FOR LOCATION
(E.3)	CARGO CLIMBING NET  TO DIA. POLYESTOR 3 STRAND BORDER ROPE W/3" SQUARE OPENINGS	BLACK	POWDER COAT	CONTACT" JASON BOSCH COMPANY: TREE HOUSE SUPPLIES INC. 610-701-2458 EXT 406	CONTRACTOR TO PROVIDE CUT SHEET TO LANDSCAPE ARCHITECT PRIOR TO ORDERING, STAKE LOCATION IN FIELD FOR LOCATION
(E.4)	FARM PUMP	RED	POWDER COAT	CONTACT: LAURA GUSCOTT COMPANY: GORIC PHONE: (877) 467-4287	CONTRACTOR TO PROVIDE CUT SHEET TO LANDSCAPE ARCHITECT PRIOR TO ORDERING, STAKE LOCATION IN FIELD FOR LOCATION
(E.5)	GOLD MINER'S SLUICEWAY  - (1) LOW LEGS, 3' LENGTH  - (1) MEDIUM LEGS, 4' LENGTH  - (1) HIGH LEGS, 3' LENGTH	N/A	POWDER COAT	CONTACT: ETHAN KING COMPANY: NATURAL PLAYGROUNDS www.naturalplaygroundsstore.com	CONTRACTOR TO PROVIDE CUT SHEET TO LANDSCAPE ARCHITECT PRIOR TO ORDERING, STAKE LOCATION IN FIELD FOR LOCATION
(E.6)	WOOD BLOCKS LARGE BLOCK SET 60 PCS	NATURAL	N/A	CONTACT: ETHAN KING COMPANY: NATURAL PLAYGROUNDS www.naturalplaygroundsstore.com	CONTRACTOR TO PROVIDE CUT SHEET TO LANDSCAPE ARCHITECT PRIOR TO ORDERING, STAKE LOCATION IN FIELD FOR LOCATION
SITE F	URNISHINGS		•		
(F.1)	ADIRONDACK CHAIRS (4) POLYWOOD MODERN ADIRONDACK	VARIOUS COLORS		POLYWOOD (855) 935-5550	CONTRACTOR TO SUBMIT PRODUCT DATA AND COLOR SAMPLES TO L.A. FOR APPROVAL PRIOR TO CONSTRUCTION.
(F.2)	NOT USED	NOT USED	NOT USED	NOT USED	NOT USED
(F.3)	6' BENCH DUMOR MODEL: 93-60, SURFACE PLATE	BLACK	POWDER COAT	CONTACT: PAUL E. ALLEN CO. PHONE: (713) 869-2673	CONTRACTOR TO SUBMIT PRODUCT DATA AND COLOR SAMPLES TO L.A. FOR APPROVAL PRIOR TO CONSTRUCTION.
F.4	(2) 6' MEMORIAL BENCHES DUMOR MODEL: 93-60, SURFACE PLATE	BLACK	POWDER COAT	CONTACT: PAUL E. ALLEN CO. PHONE: (713) 869-2673	CONTRACTOR TO COORDINATE (4) MEMORIAL PLAQUES WITH PAUL E. ALLEN. ONE ON EACH BENCH AND 2 EXTRAS RE: DETAIL FOR TEXT
F.5	TRASH RECEPTACLE DUMOR MODEL NO: 84-32, SURFACE PLATE	BLACK	POWDER COAT	CONTACT: PAUL E. ALLEN CO. PHONE: (713) 869-2673	CONTRACTOR TO SUBMIT PRODUCT DATA AND COLOR SAMPLES TO L.A. FOR APPROVAL PRIOR TO CONSTRUCTION.

MATERIALS SCHEDULE

STONE					
(S.1)	DECOMPOSED GRANITE - ½"-	BROWN	N/A	CONTACT: HEATHER TITO COMPANY: ALAMO STONE PHONE: (281) 723-4148	
S.2	DRY CREEK RIVER ROCK - 2"-4"		SIENNA COBBLE	CONTACT: HEATHER TITO COMPANY: ALAMO STONE PHONE: (281) 723-4148	
5.3	BOULDERS, VARIOUS SIZES - 25% TYPE A: 12" MIN 18" MAX. (LENGTH) 6" MIN 9" MAX. (HEIGHT) - 50% TYPE B: 18" MIN 30" MAX. (LENGTH) 9" MIN 12" MAX. (HEIGHT) - 25% TYPE C: 24" MIN 36" MAX. (LENGTH) 18" MIN 30" MAX. (HEIGHT)		N/A	CONTACT: HEATHER TITO COMPANY: ALAMO STONE PHONE: (281) 723-4148	CONTRACTOR TO SUBMIT PHOTOS OF ALL BOULDERS FOR LANDSCAPE ARCHITECT APPROVAL.
WOOD					
(W.1)	LOG PILES - MCQ AND KDAT TREATMENT TO MIN. GROUND CONTACT - 6" MIN. TO 15" MAX. DIA.	NATURAL	N/A	LOCAL SOURCE	REF. SPECS FOR SUBMITTAL REQ'S.
(W.2)	UNPEELED CEDAR	NATURAL	N/A	LOCAL SOURCE	
(W.3)	TIMBERS / TIMBER STEPS - 8" X 8" LUMBER	TREATED		LOCAL SOURCE	
MISCE	LLANEOUS				
Z.1	WOOD FIBAR MULCH	NATURAL	N/A	LOCAL SOURCE	CONTRACTOR TO PROVIDE CUT SHEET TO LANDSCAPE ARCHITECT PRIOR TO ORDERING, STAKE LOCATION IN FIELD FOR LOCATION
7.2	SAND	NATURAL	N/A	LOCAL SOURCE	REF. SPECS FOR SUBMITTAL REQ'S.
Z.3	ART NOOK	N/A	N/A	CONTACT: MATTHEW RENFROW COMPANY: RENFROW+CO. PHONE: (832) 724-8517 (713) 588-1768	- NO SUBSTITUTIONS ALLOWED
7.4	PAVILION MOD PAVILION AT 20'W X 18' D WITH STANDING SEAM METAL ROOF			JASON RATLIFF COVER TIMBERWORKS 830-822-0693 JASON@COVERTIMBERWORKS.COM WWW.COVERTIMBERWORKS.COM	CONTRACTOR TO PROVIDE CUT SHEET TO LANDSCAPE ARCHITECT PRIOR TO ORDERING, STAKE LOCATION IN FIELD FOR LOCATION



DRY CREEK BED AND BOULDERS - INTENT AND CHARACTER



SEEDED CONCRETE- INTENT AND CHARACTER



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### echo park at riverstone

Taylor Morrison Missouri City, Texas


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### material schedule

LC 1.2





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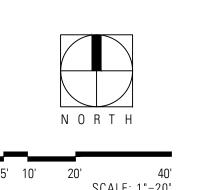
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overall reference plan

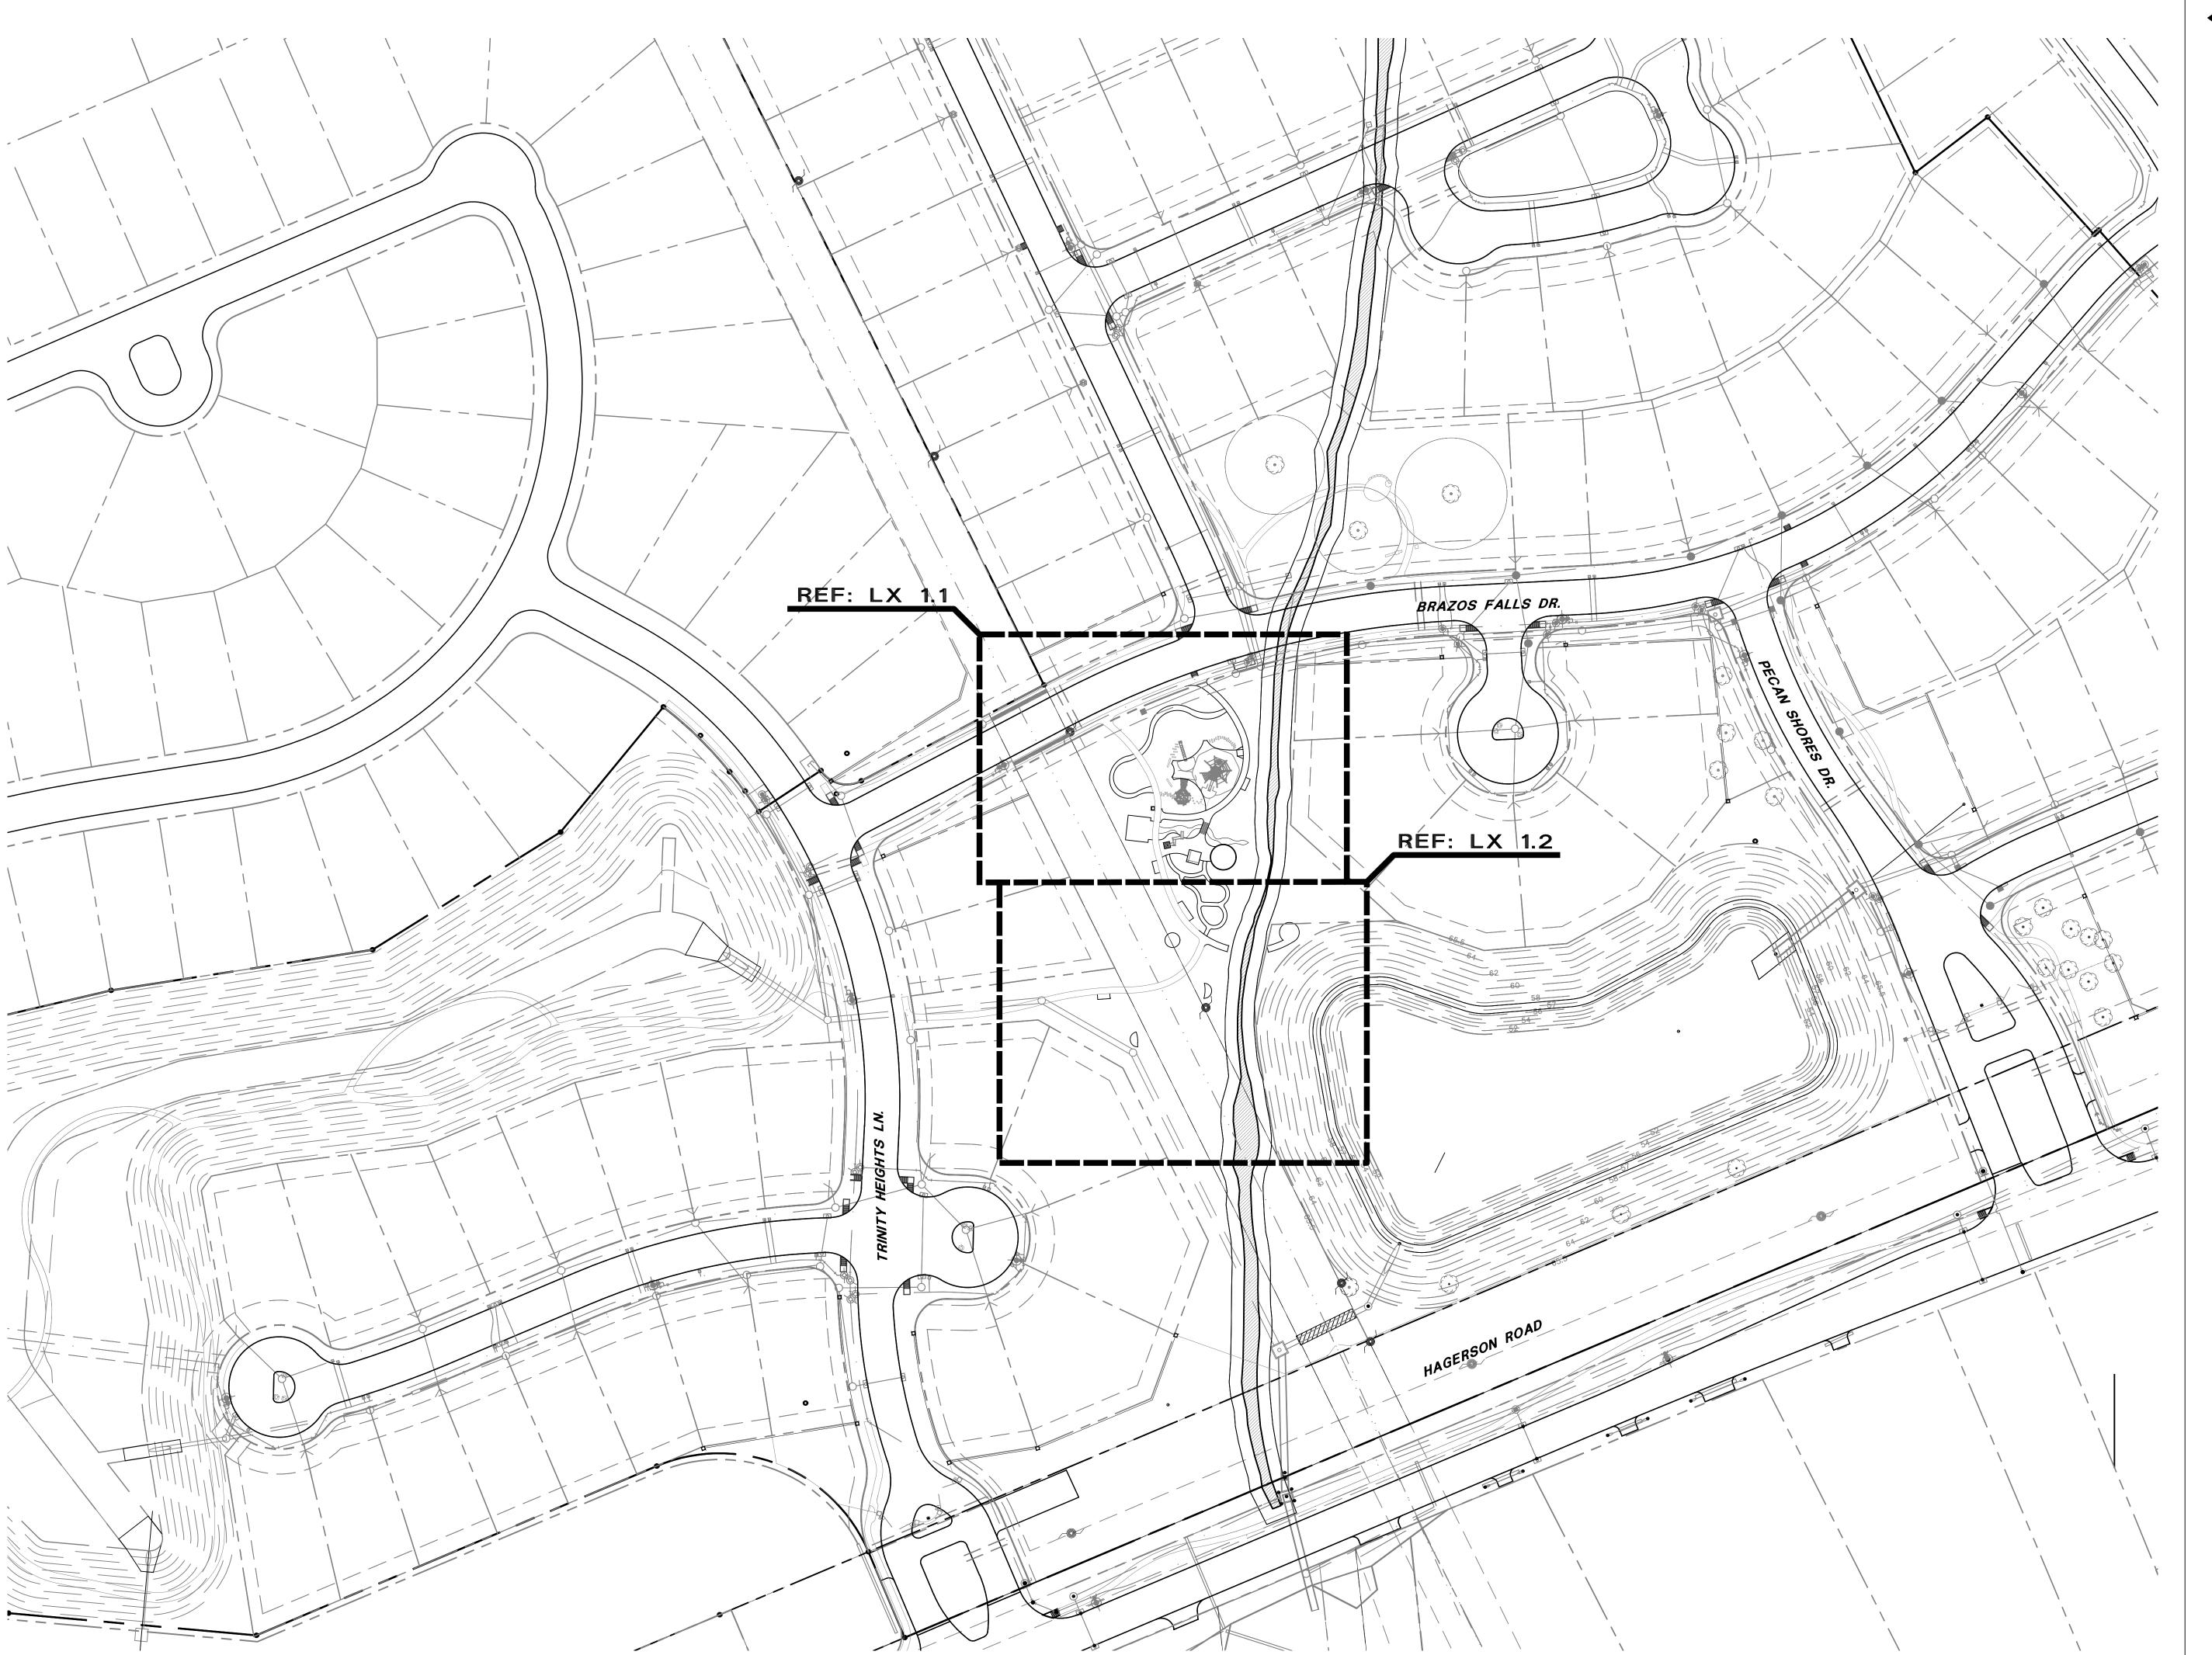LC 1.3

NOTE: CONTRACTOR TO PROTECT ALL TREES NEAR WORKING AREA AND IS RESPONSIBLE FOR DAMAGES





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tree protection plan

LD 1.1

#### **GENERAL GRADING NOTES**

- 1. REFERENCE LG 2.1 FOR DRAIN INVERT ELEVATIONS \$ ALL
- INSURE POSITIVE DRAINAGE OF ALL HARDSAPE AND LANDSCAPE AREAS
   ALL GRADES WITHIN ACCESSIBLE ROUTES SHALL CONFORM TO TAS STANDARDS
- 4. CONTRACTOR TO SHAPE EXTENTS OF GRADING NEAR LIMIT OF CONSTRUCTION TO CONNECT TO EXISTING GRADES IN SMOOTH TRANSITIONS AS INSTRUCTED BY LANDSCAPE ARCHITECT.

<u>LAYOUT NOTE:</u>
CONTRACTOR TO REQUEST COORDINATE SCHEDULE FROM LANDSCAPE ARCHITECT FOR LOCATION OF ALL DRAIN INLETS.

#### **GRADING LEGEND**

56.23	PROPOSED SPOT ELEVATION (BY LANDSCAPE ARCHITECT)
56.31	EXISTING SPOT ELEVATION (BY CIVIL ENGINEER)
TW	TOP OF WALL ELEVATION
ВМ	BOTTOM OF WALL ELEVATION
TS	TOP OF STAIR ELEVATION
BS	BOTTOM OF STAIR ELEVATION
TD	TOP OF DRAIN INLET ELEVATION
HP	HIGH POINT ELEVATION
LP	HIGH POINT ELEVATION
SG	SUBSURFACE GRADE ELEVATION
TC	TOP OF CURB ELEVATION
BC	BOTTOM OF CURB ELEVATION
JB	JUNCTION BOX ELEVATION
MH	MANHOLE RIM ELEVATION
INV.	CATCH BASIN OR PIPE INVERT ELEVATION
P.O.C.	POINT OF CONNECTION
<del></del>	PERCENT & DIRECTION OF SLOPE
	EXISTING MINOR CONTOUR
	EXISTING MAJOR CONTOUR
561	PROPOSED MINOR CONTOUR
560	PROPOSED MAJOR CONTOUR
··· <del>-</del>	SURFACE FLOW LINE (SWALE)
	GRADE BREAKLINE
	DRAIN LINE- SDR 35. REFER. D.I PLAN FOR SIZING.

#### **BERM NOTES:**

\_\_\_\_\_

1.) VERIFY EXISTING CONTOURS AS SHOWN. FINAL LOCATION AND LAYOUT OF BERMS TO BE APPROVED IN FIELD BY THE LANDSCAPE ARCHITECT. CONTRACTOR SHALL ROUGH GRADE AND DRAG FINISH ALL GRADING PER APPROVAL OF THE LANDSCAPE ARCHITECT. BERMS SHALL BE PLACED WITHIN + 1/10' VERTICALLY AND + 1' HORIZONTALLY AS SHOWN ON PLANS.

SDR 35 PERFORATED DRAIN LINE. REFER. PLAN FOR SIZING. D.2

- 2.) ALL BERMS SHALL HAVE MAXIMUM 3:1 SLOPES UNLESS OTHERWISE NOTED.
- 3.) GRADE ALL SLOPES FOR POSITIVE DRAINAGE AND TO PREVENT WATER FROM STANDING. CONTRACTOR SHALL ENSURE THAT BERMS DO NOT OBSTRUCT DRAINAGE FLOW. NOTIFY LANDSCAPE ARCHITECT IMMEDIATELY SHOULD SUCH CONDITIONS ARISE. CUT SWALES TO DIRECT WATER AWAY FROM PROPERTY LINE \$ FENCE. CONTRACTOR SHALL NOT DRAIN ANY WATER TOWARDS LOT.
- 4.) ALL SLOPES SHALL BE SMOOTH AND UNIFORM. LEVEL AND GENTLY CROWN TOP OF BERMS. BLEND TOE OF BERMS INTO EXISTING GRADES.
- 5.) CONTRACTOR TO NOTIFY OWNER OF ANY MANHOLE OR UTILITY BOX ADJUSTMENTS REQUIRED PRIOR TO PLACING ANY FILL. LOCATIONS OF ALL UTILITIES SHOWN ON PLANS ARE APPROXIMATE AND SHALL BE VERIFIED IN FIELD. CONTRACTOR IS RESPONSIBLE FOR UNCOVERING ALL CONCEALED UTILITIES AND PROPERTY MARKERS UPON COMPLETION OF WORK. CONTRACTOR TO WALK SITE WITH OWNER PRIOR TO FINAL PAYMENT TO ENSURE MANHOLES AND GATE VALVES ARE EXPOSED.
- 6.) CONTRACTOR TO ASSUME BALANCED CUT \$ FILL ON SITE.





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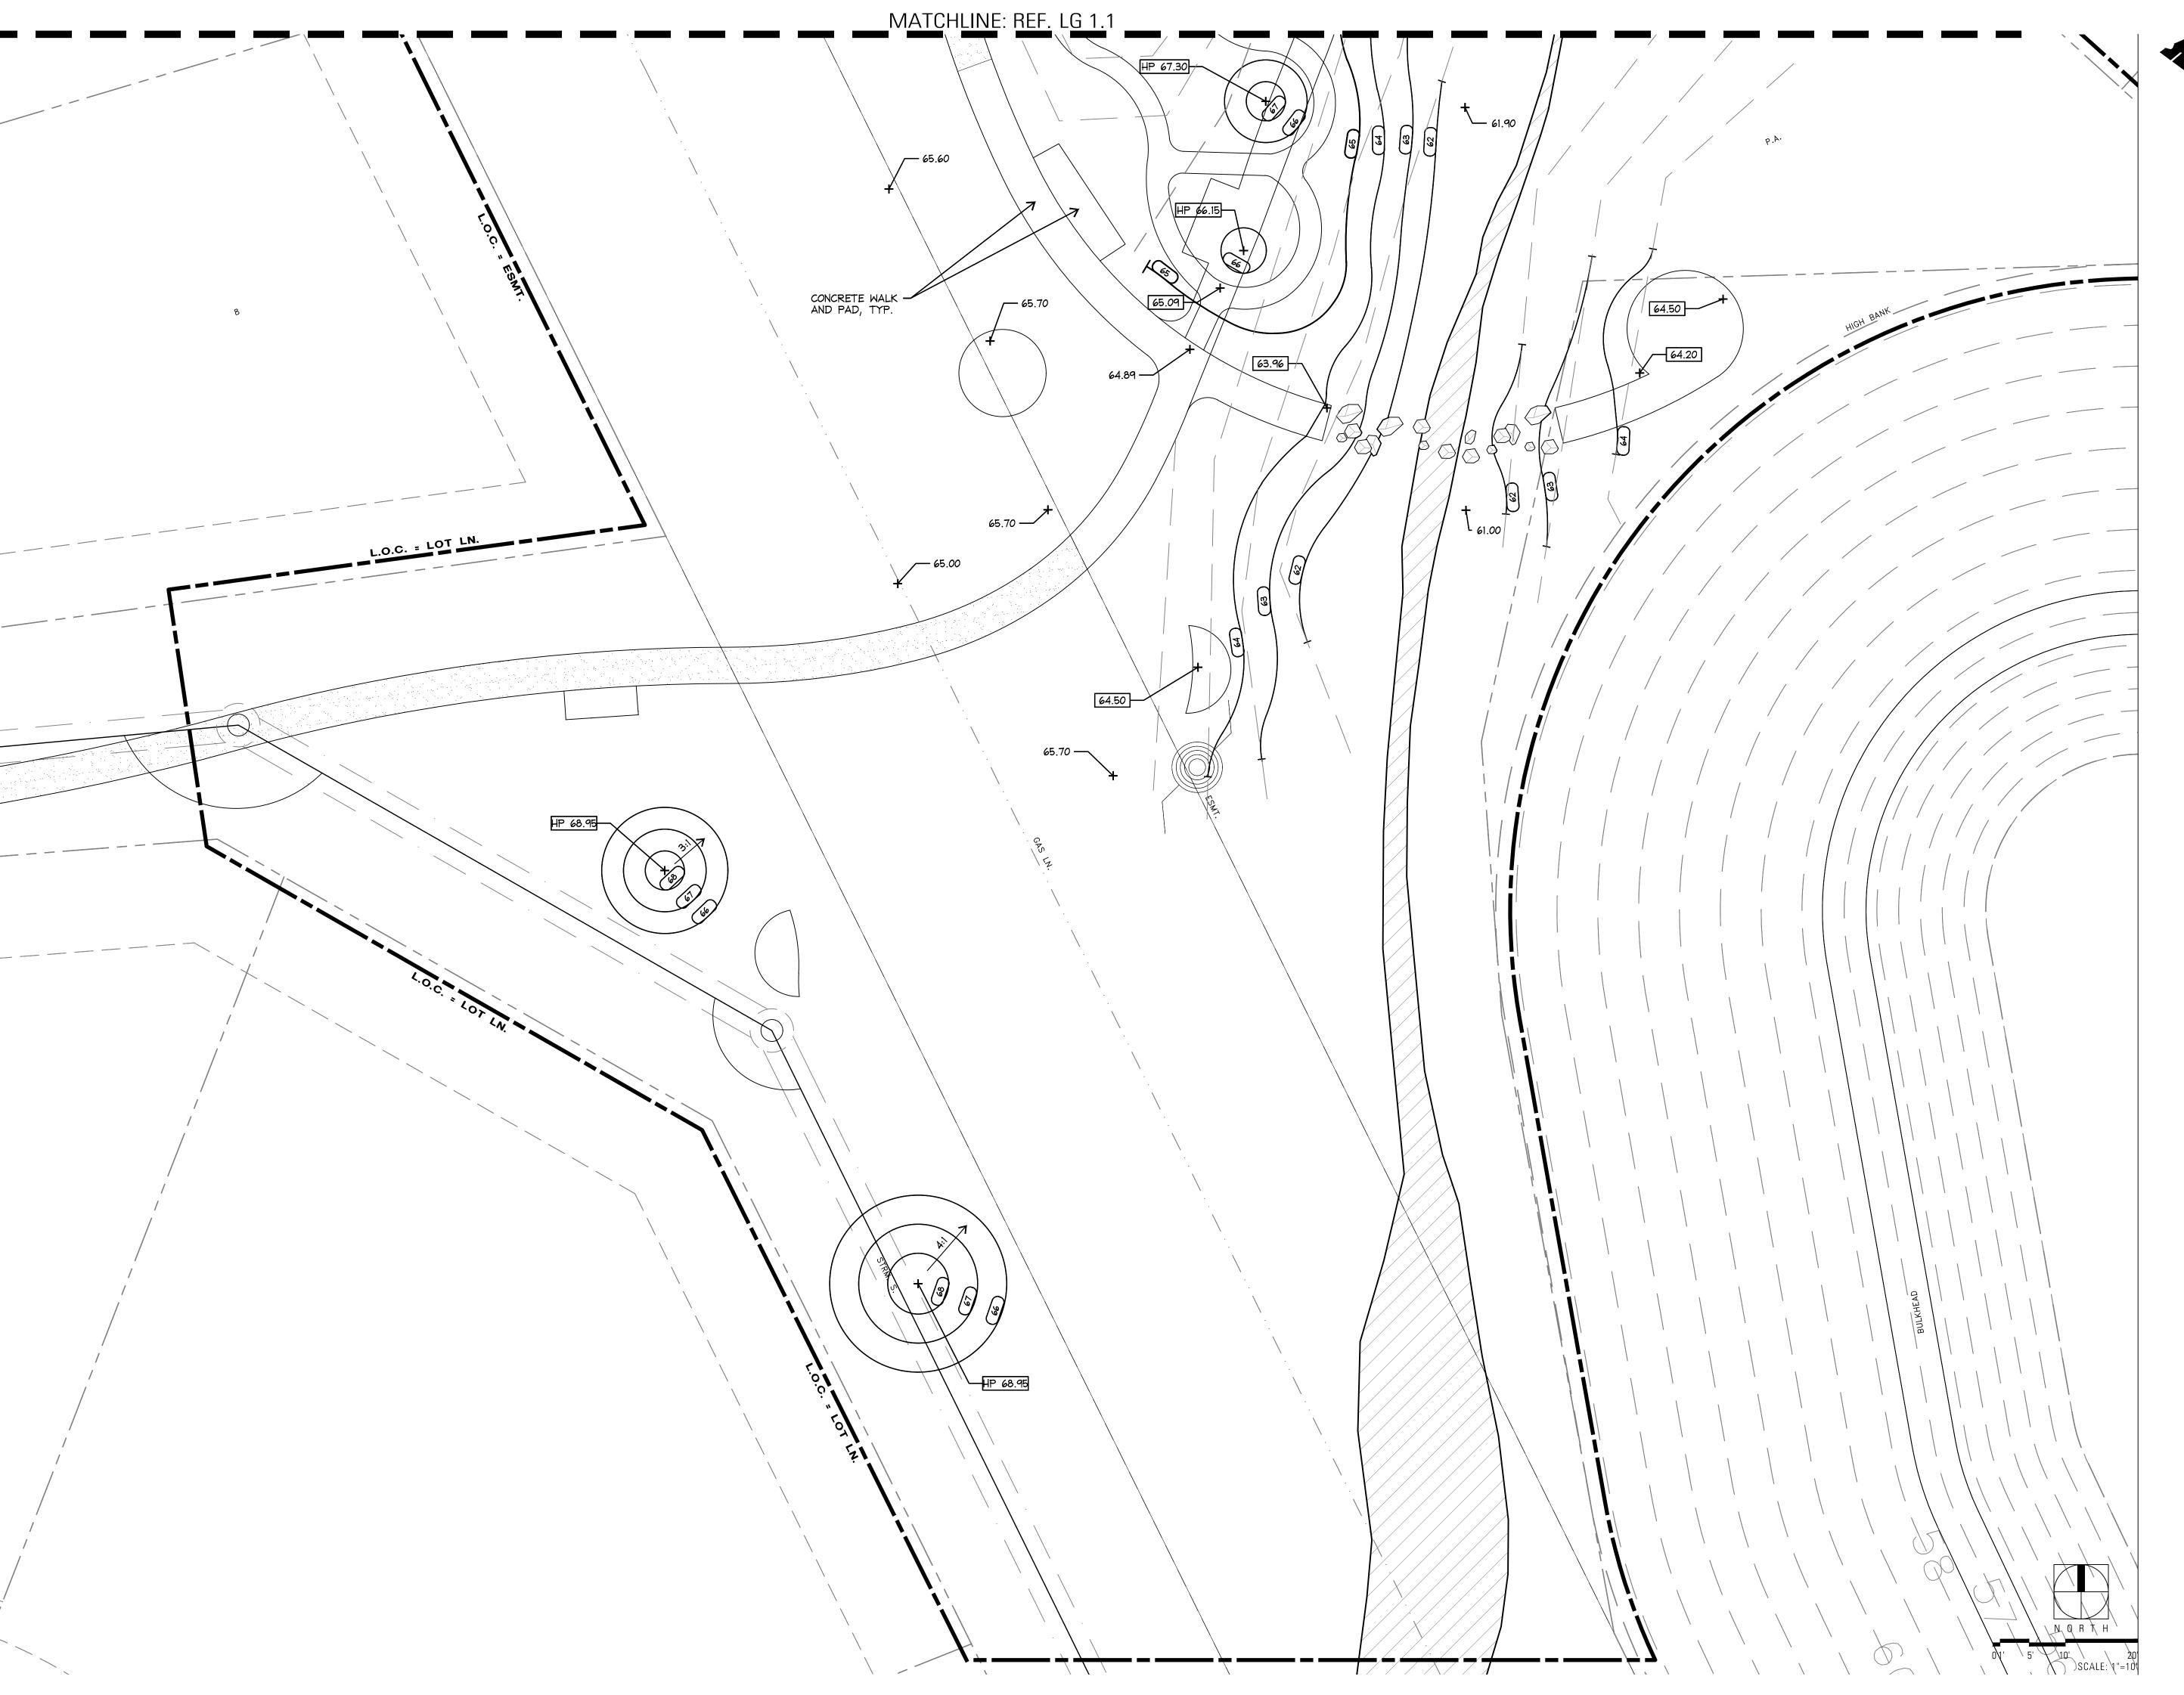
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grading & drainage plan

LG 1.1





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LG 1.2



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sitework plan

LS 1.1



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echo park at riverstone

Taylor Morrison Missouri City, Texas


H20378

issue date June 2, 2021

designed: AW JS drawn: AW ES reviewed: JZ MM

sitework plan

LS 1.2

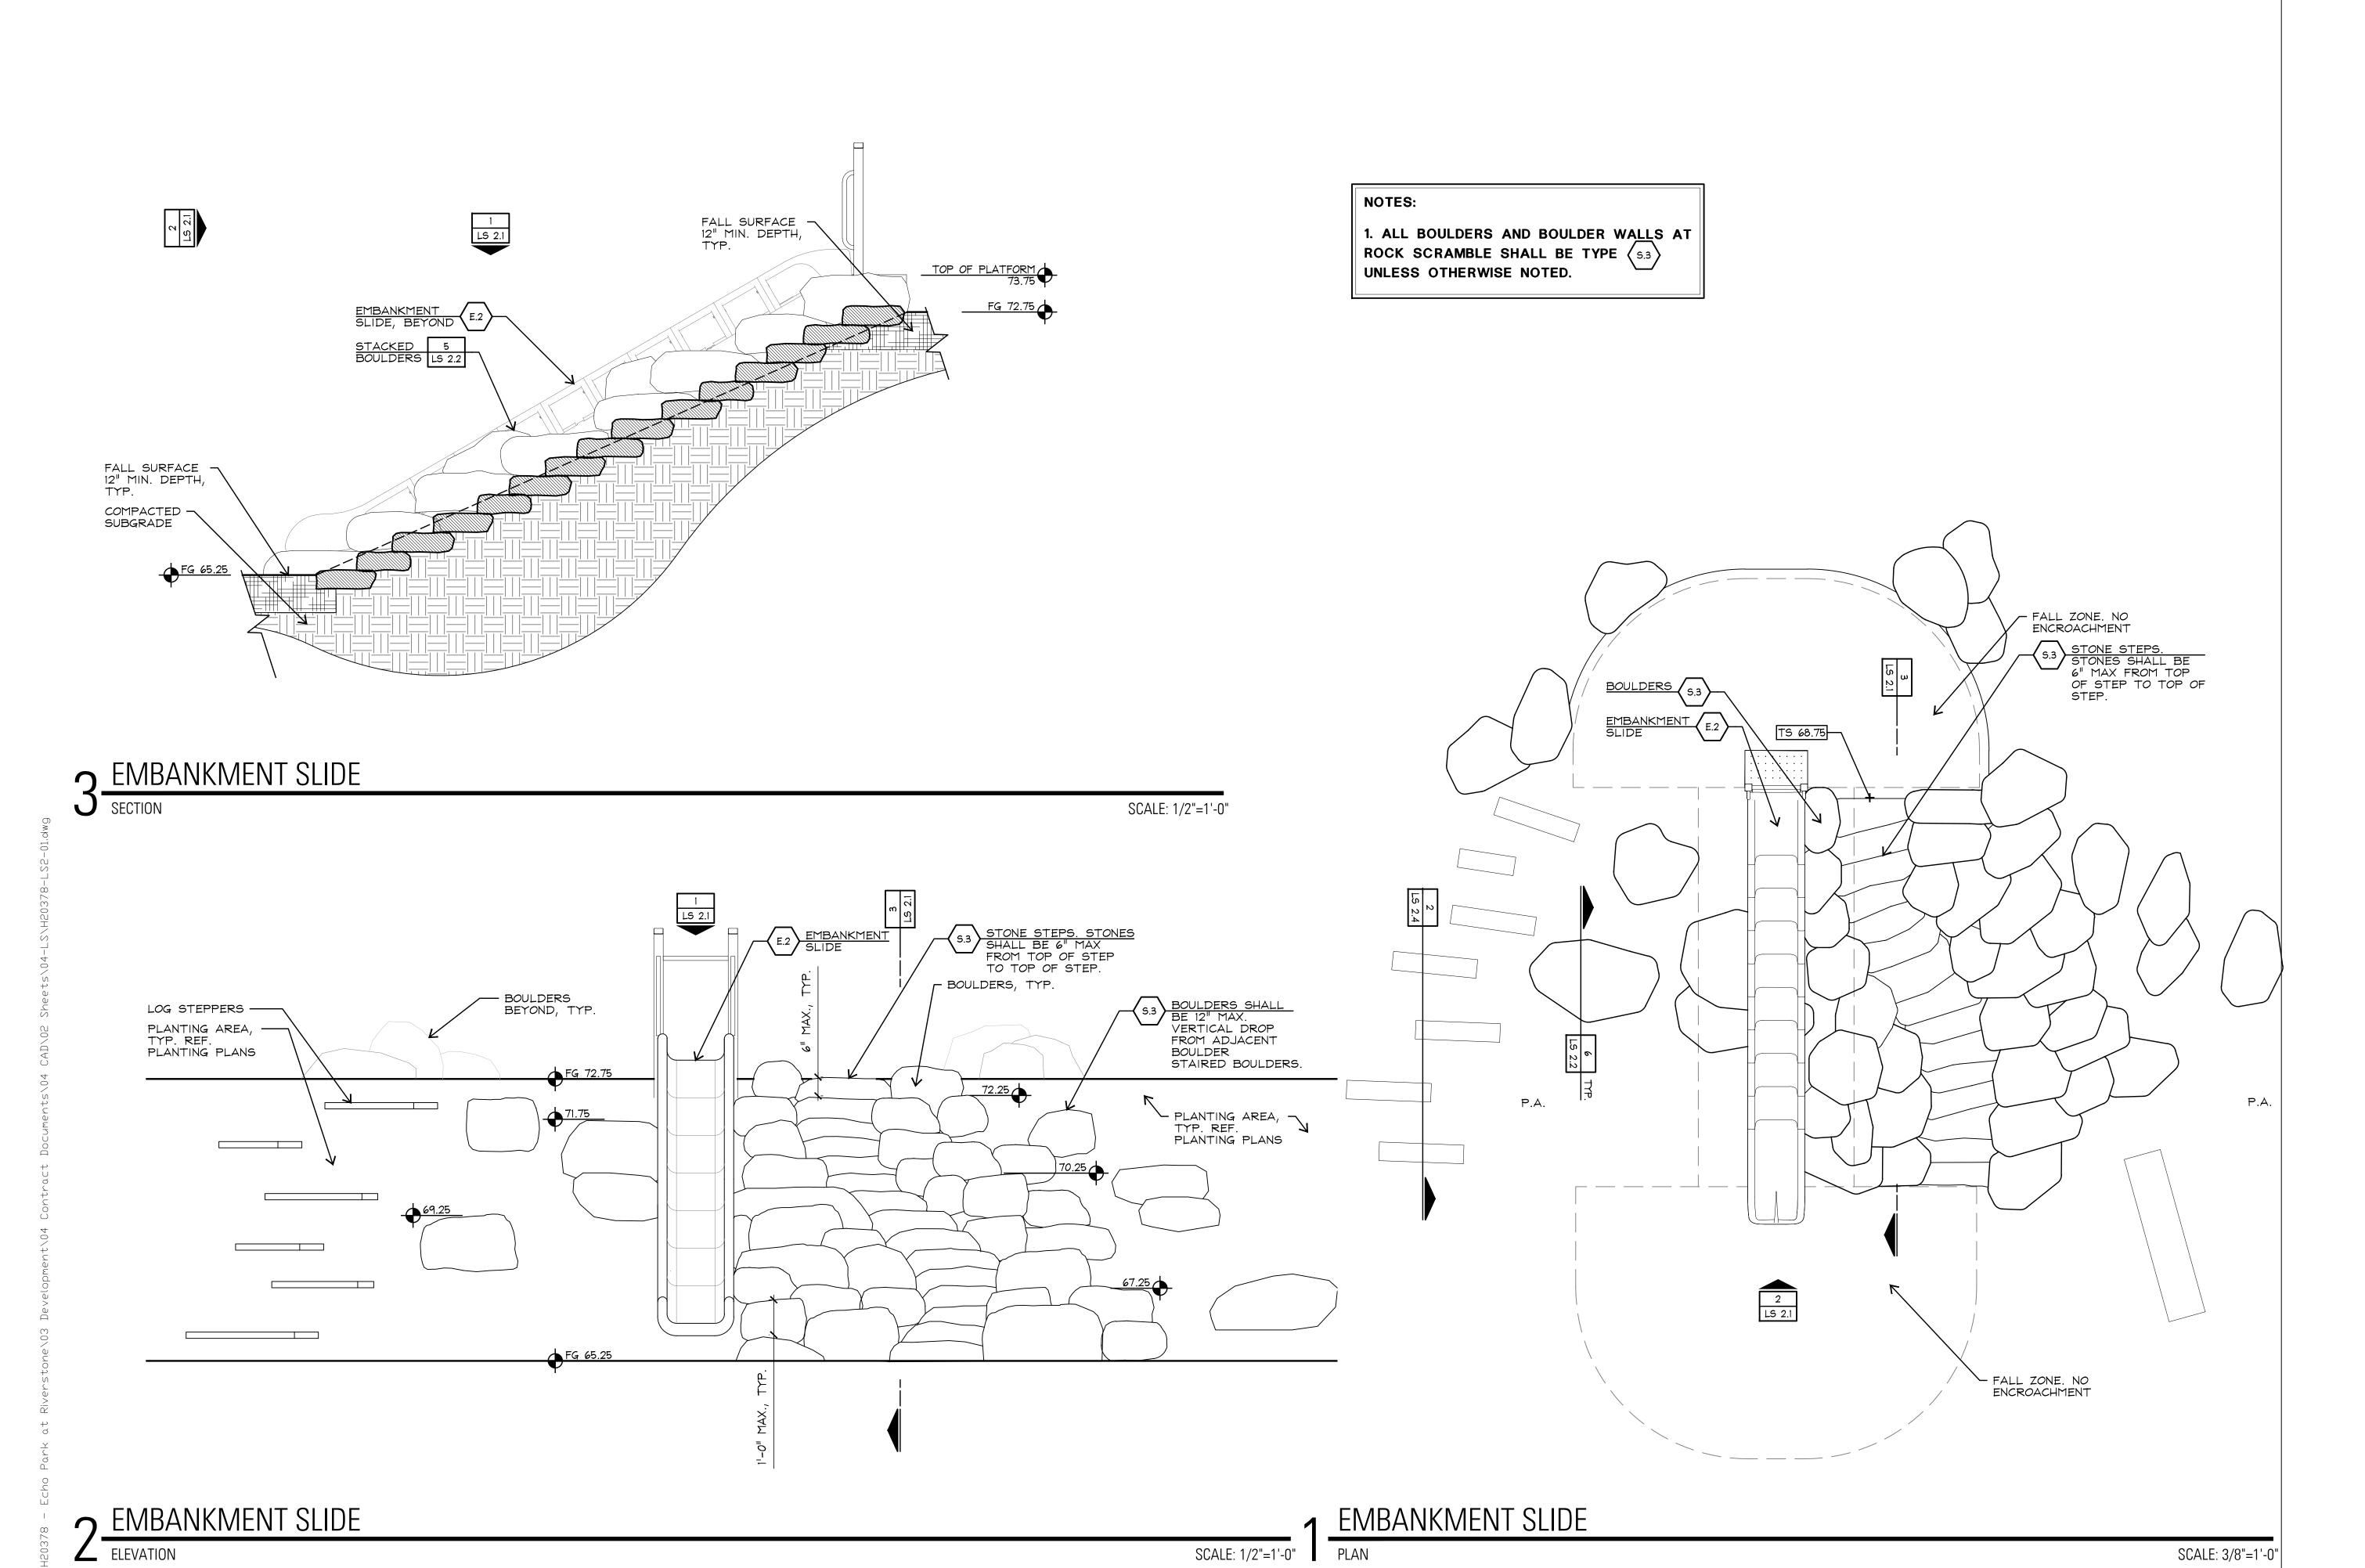



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project

# echo park at riverstone

Taylor Morrison Missouri City, Texas

### H20378


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designed: AW JS drawn: AW ES MF reviewed: JZ MM

embankment slide details


# 6 TYPICAL BOULDER (SINGLE) SECTION

SCALE: 1"=1'-0"

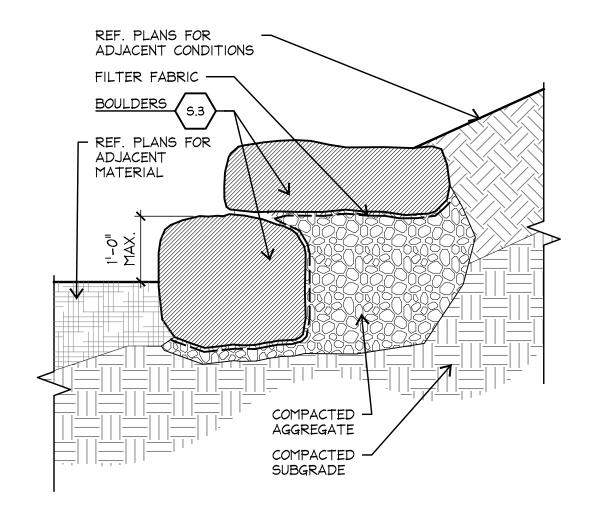


## 5 TYPICAL STACKED BOULDERS SECTION

SCALE: 1"=1'-0"

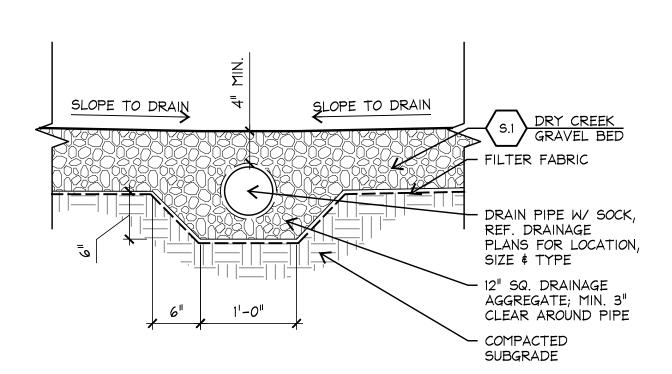


4 TYPICAL GRAVEL
SECTION SCALE: 1"=1'-0"

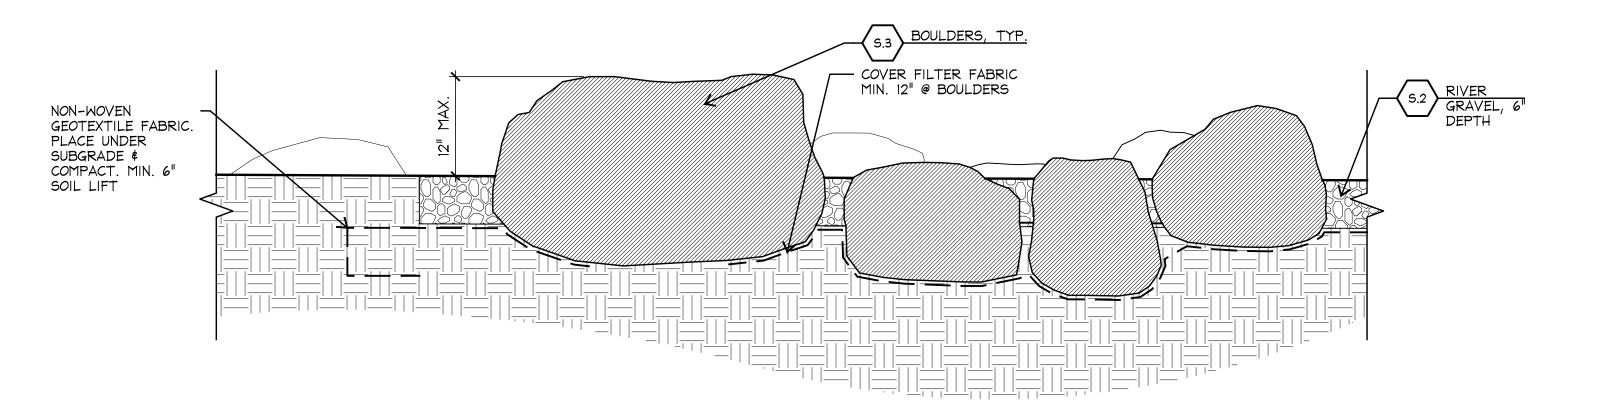


# 3 BOULDER CROSSING SECTION

SCALE: 1"=1'-0"

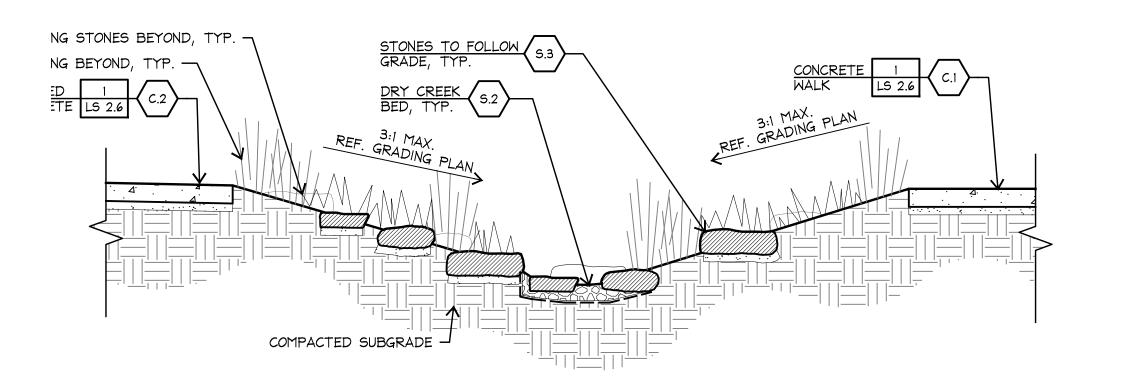

# 2 DRY CREEK 2 SECTION

SCALE: 1/2"=1'-0"

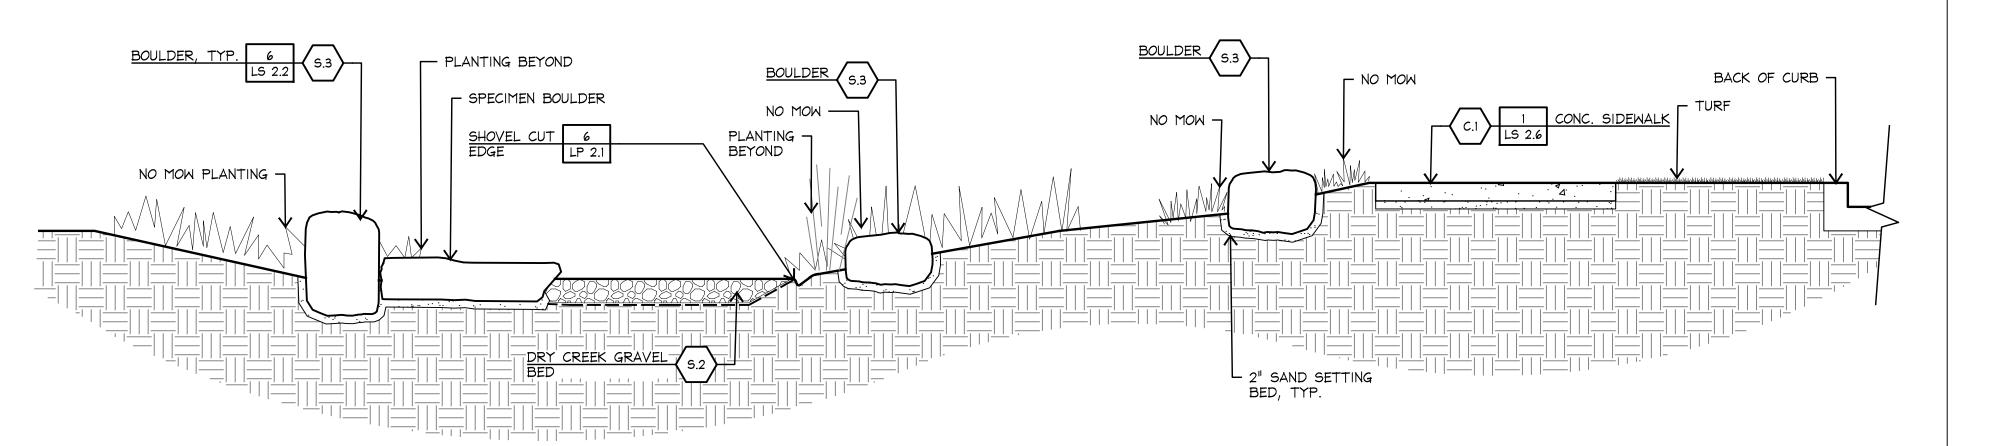

### DRY CREEK 1

SCALE: 1/2"=1'-0"



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boulder details




NOT TO SCALE

NOT TO SCALE



3 THE NEST - DESIGN INTENT

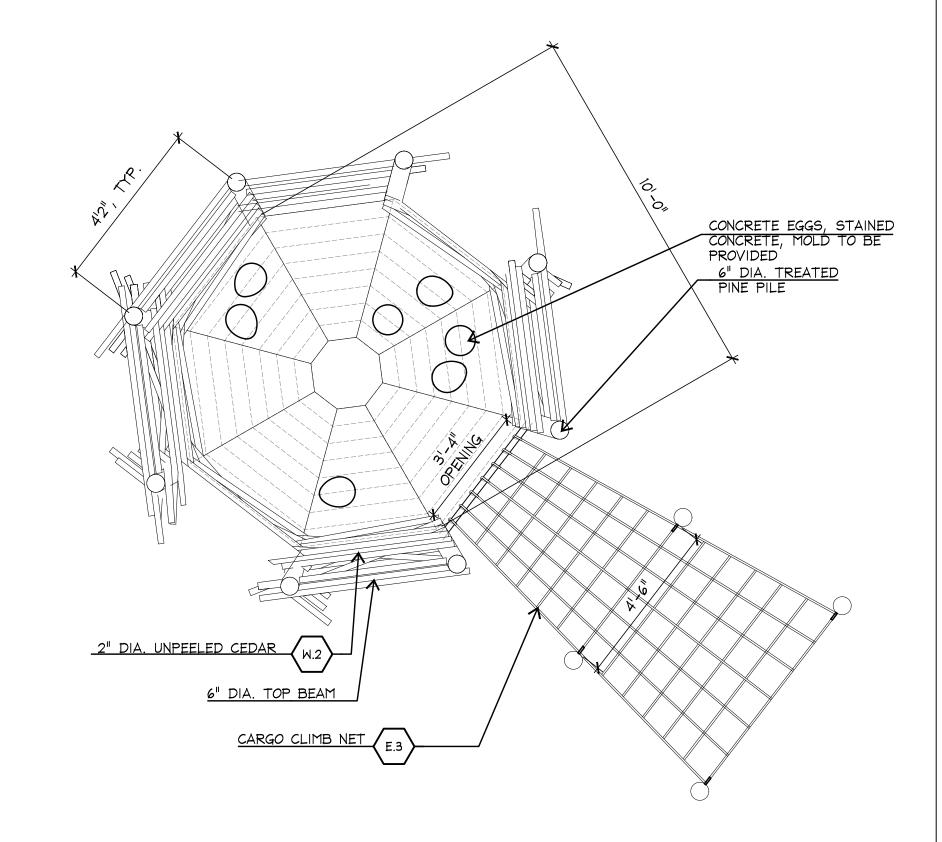



1 THE NEST - DESIGN INTENT
PLAN NOT TO SCALE



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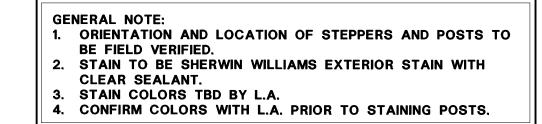
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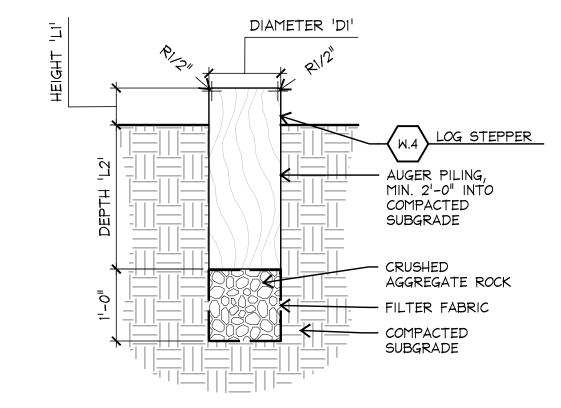
### H20378


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nest details







4 TYP. LOG PILES

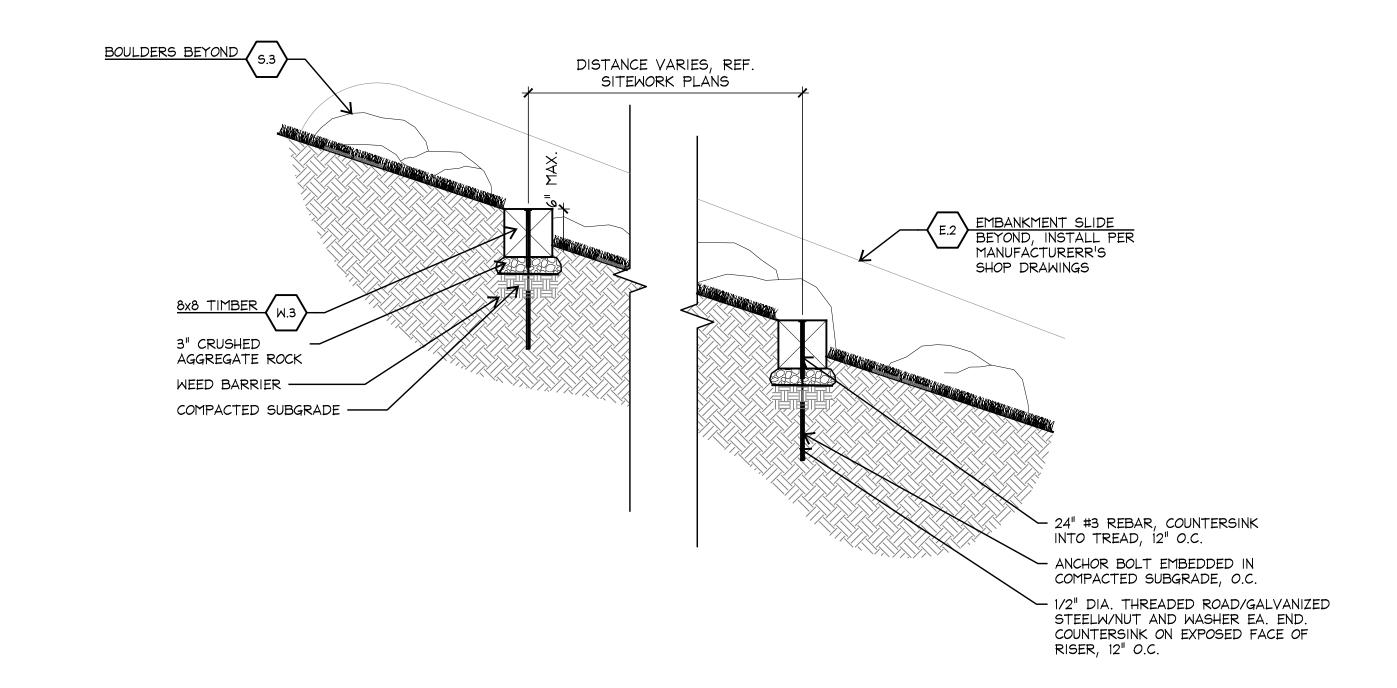SECTION SCALE: 3/4"=1'-0"

7 TIMBER STEPPERS

SCALE: 1"=1'-0"

# NOT USED

# NOT USED

2 LOG CROSSING

PLANS AND SCHEDULES

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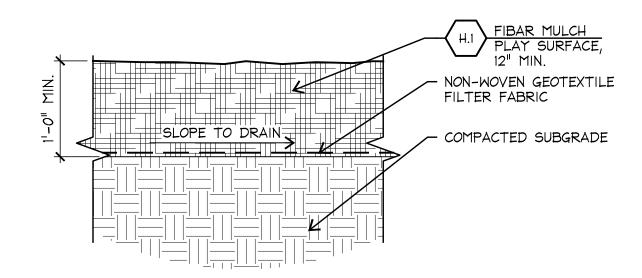
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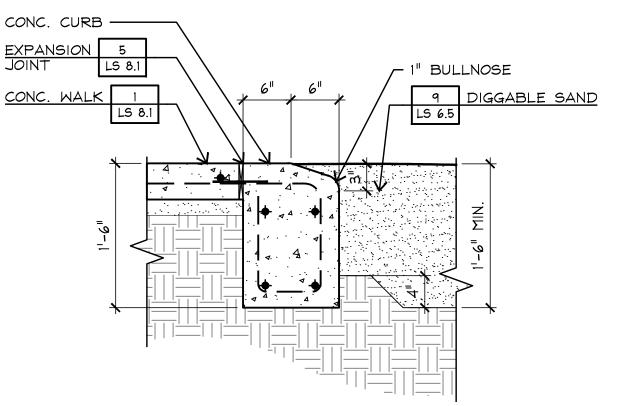
designed: AW JS drawn: AW ES MF reviewed: JZ MM

log details

6 TYPICAL SAND
SECTION SCALE: 1"=1'-0"




5 TYPICAL MULCH SECTION SCALE: 1"=1'-0" CONC. CURB ——




TYPICAL CURB AT SAND

SECTION SCALE: 1"=1'-0"

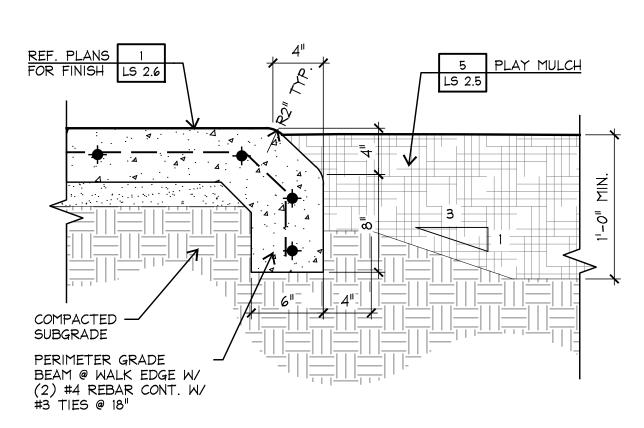


3 WALK WITH TURNDOWN
SECTION

SCALE: 1-1/2"=1'-0"

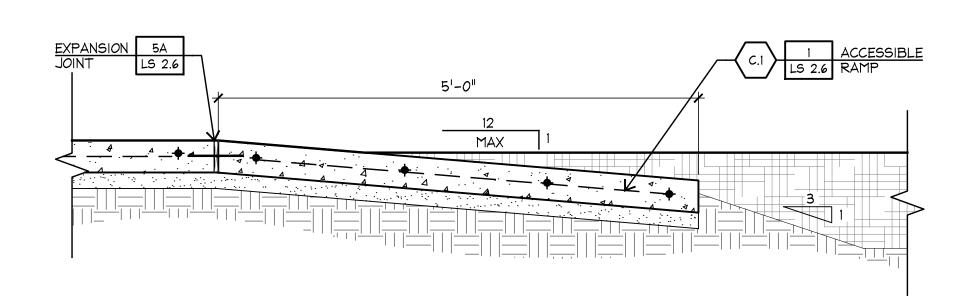

2 ADA RAMP
SECTION SCALE: 1"=1'-0"

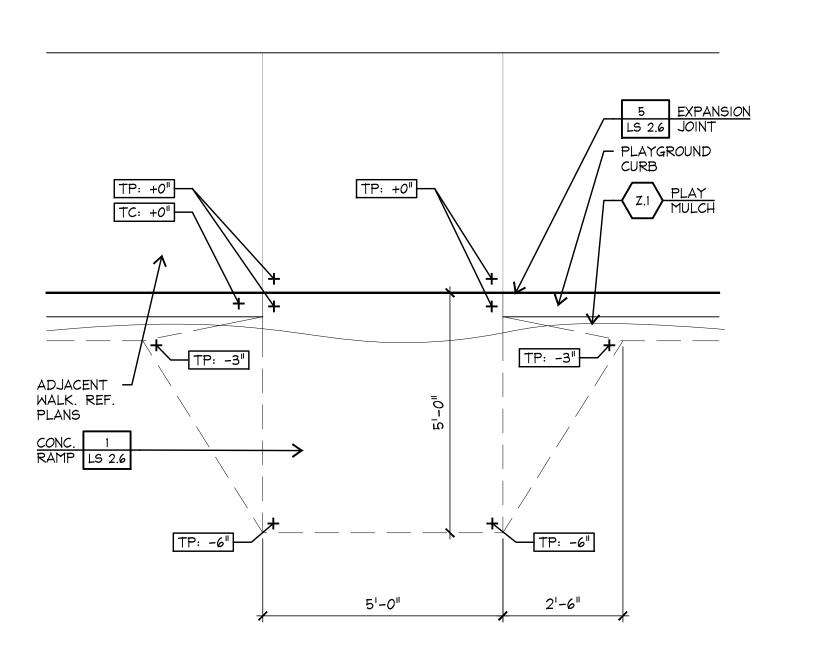

1 ADA RAMP
PLAN SCALE: 1/2"=1'-0"



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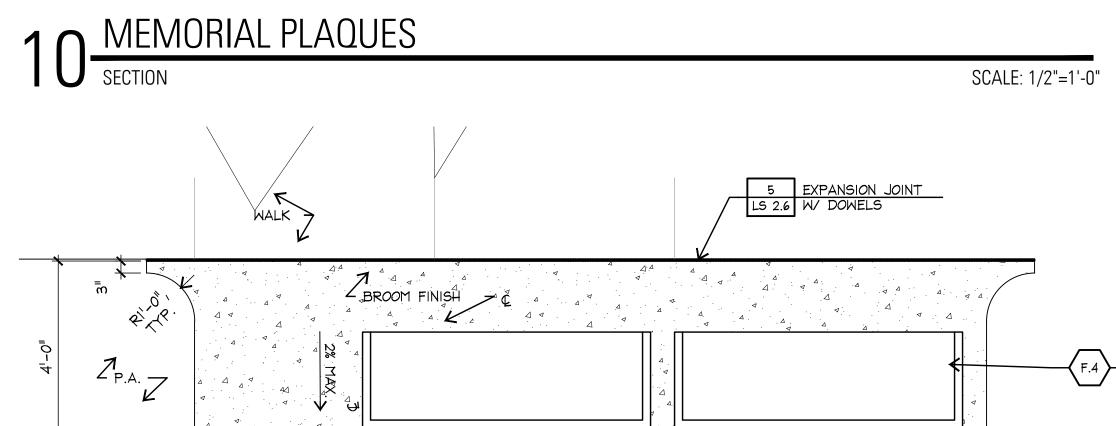
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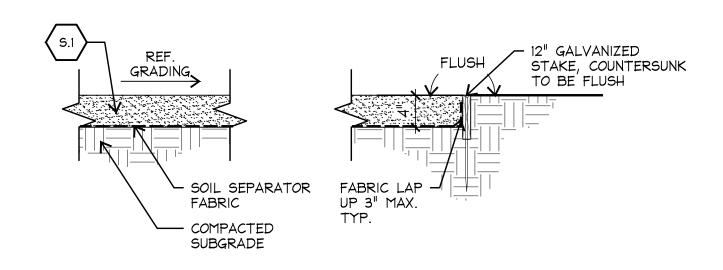
designed: AW JS drawn: AW ES MF reviewed: JZ MM

playground details


3'-6"




9 DOUBLE BENCH ON CONCRETE PAD SECTION SCALE: 1/2"=1'-0"



8 DECOMPOSED GRANITE
SECTION SCALE: 1"=1'-0"

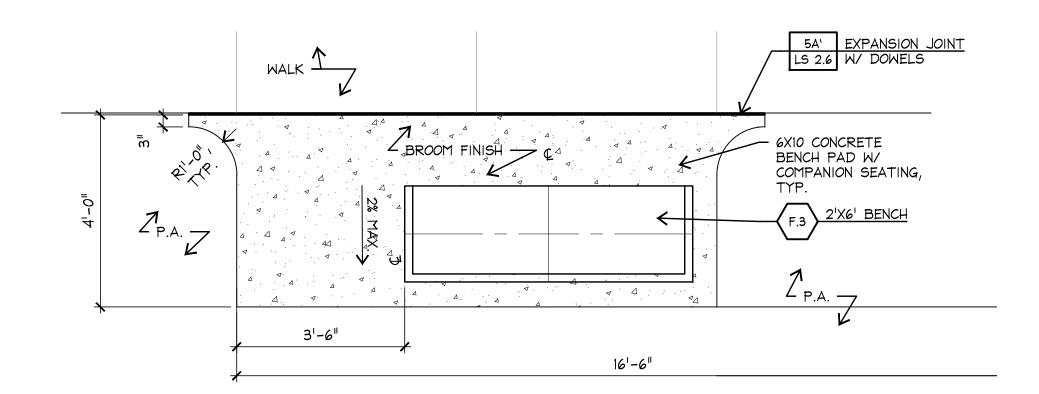


→ SINGLE BENCH ON CONCRETE PAD SCALE: 1/2"=1'-0"

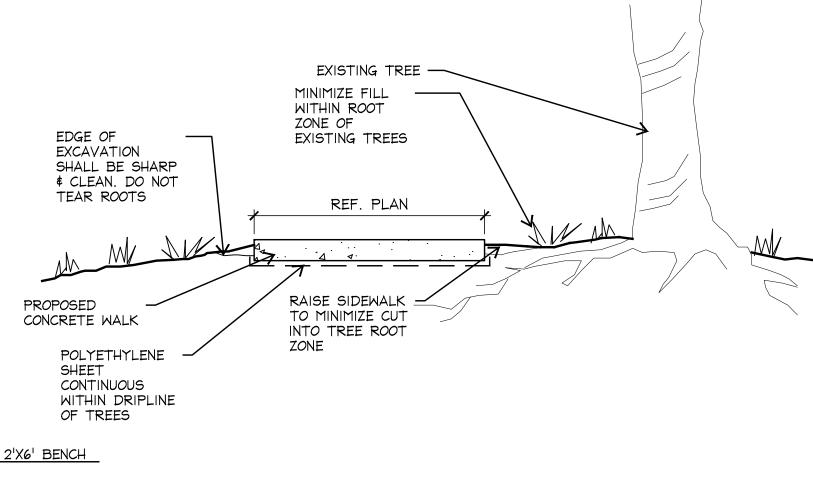


6 WALK NEAR TREE PLANTING
SECTION

SCALE: 1/2"=1'-0"

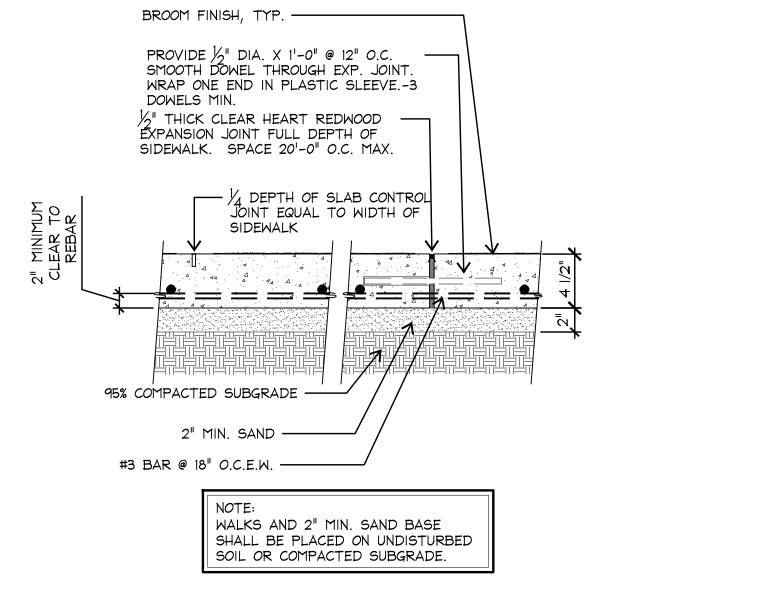

**EXPANSION AND CONTROL JOINT** SCALE: 1-1/2"=1'-0"

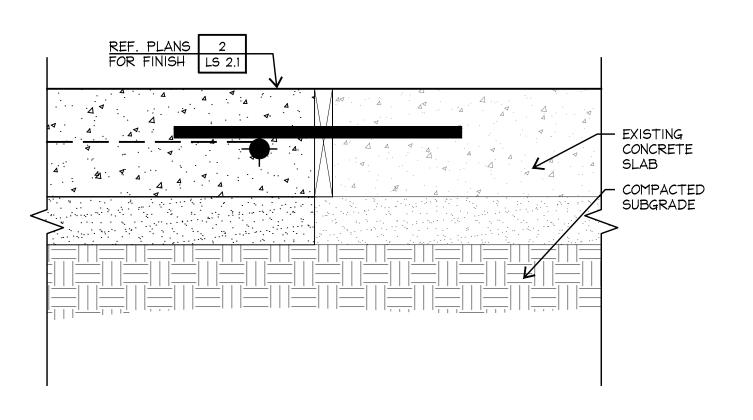


WALK TO EXISTING TO SLAB

SCALE: 3"=1'-0'

REF. PLANS FOR — CROSSSLOPE 2% MAX. R=3'-0" - TOOLED EDGE - EXPANSION JOINT (DRIVE NON-SLEEVE END OF REBAR INTO EXIST. CONC.) EXISTING WALK


3 WALK TO EXISTING WALK

SCALE: 1/4"=1'-0"

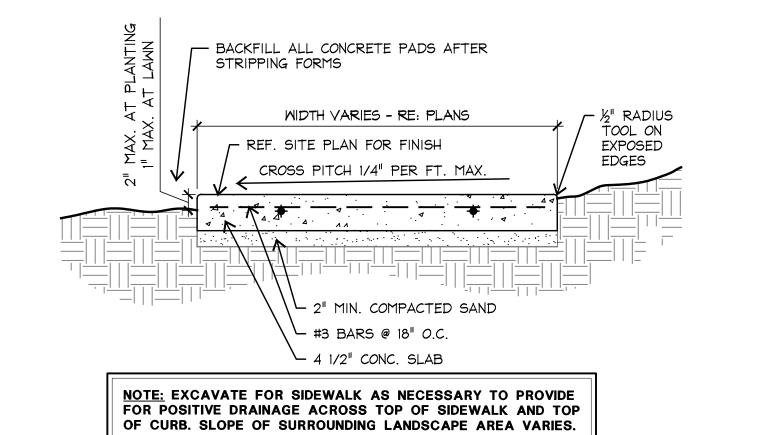

CONCRETE WALK LAYOUT

IN THE EVEN OF A CONFLICT, THE CITY OF SUGAR LAND'S DETAILS SUPERCEDE TBG PARTNERS' DETAILS

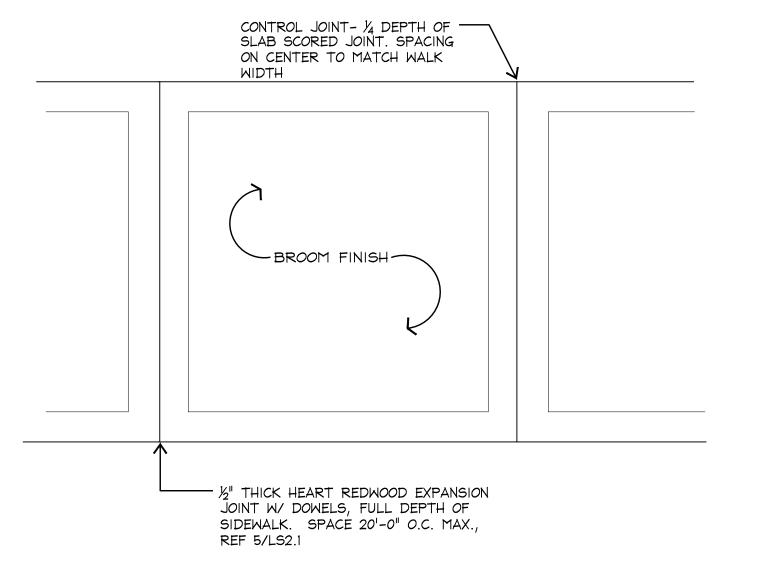

CONCRETE WALK LAYOUT

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echo park at riverstone

**Taylor Morrison** Missouri City, Texas

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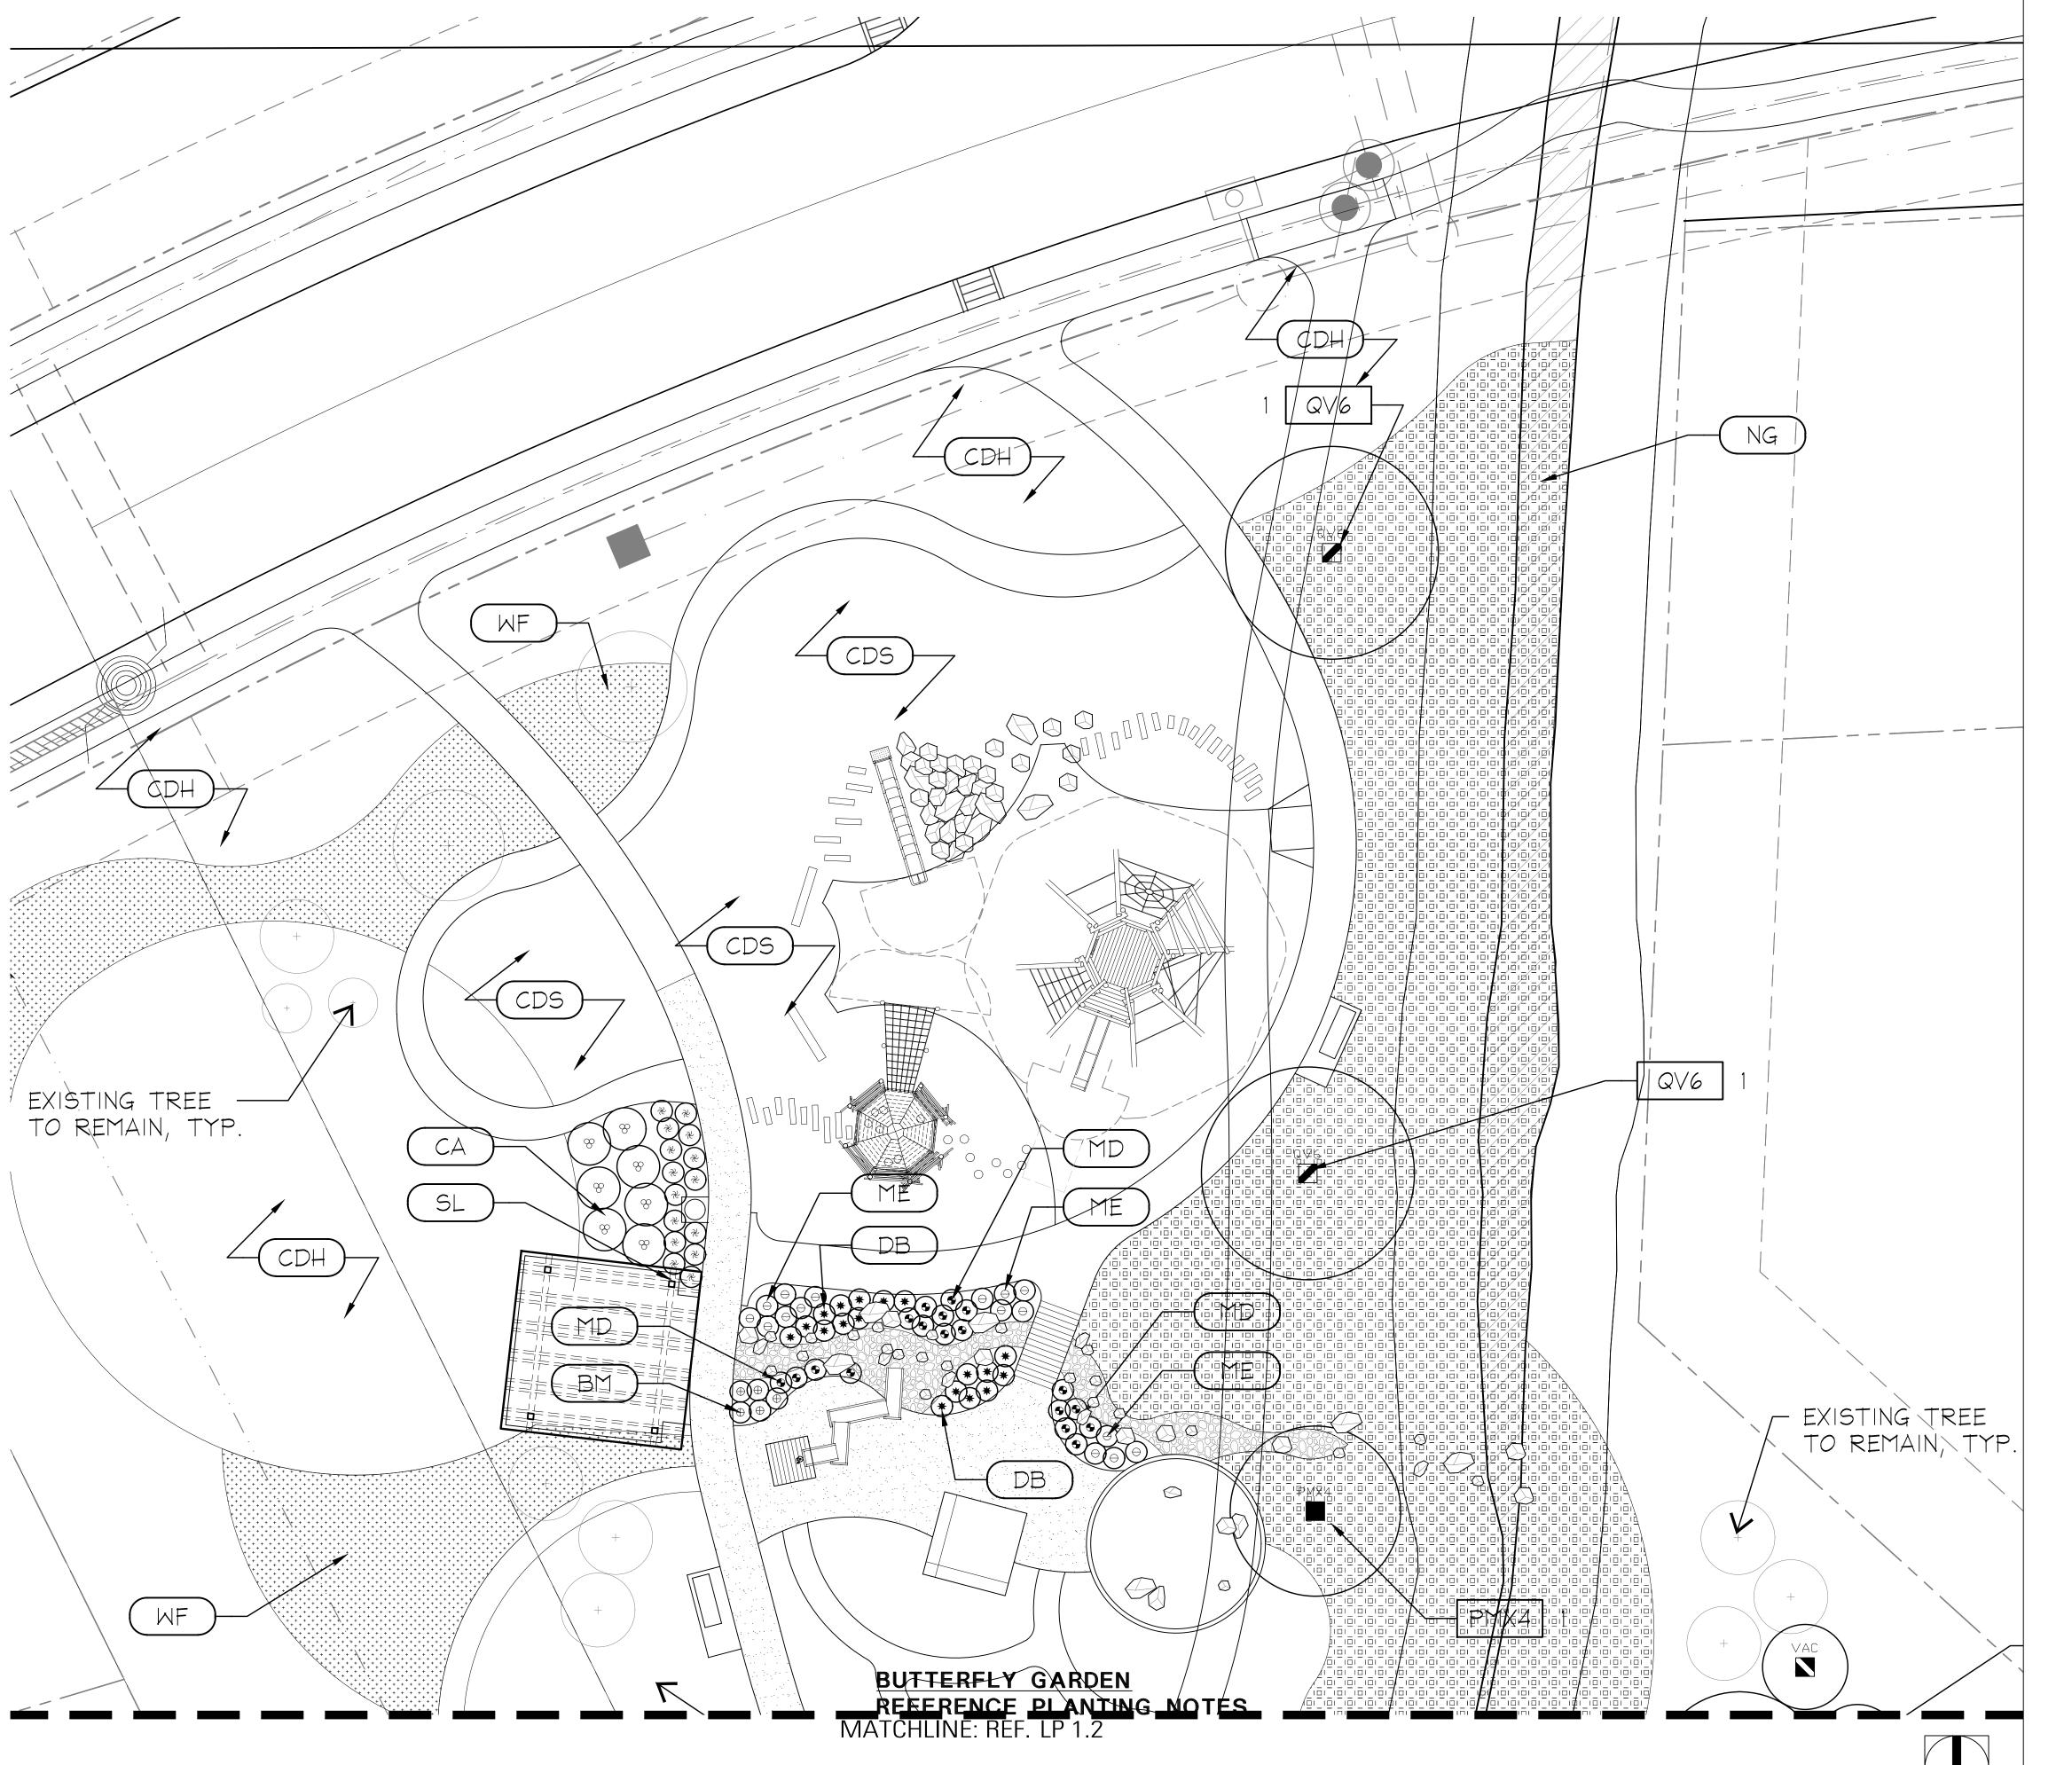
SCALE: 1"=1'-0"

SCALE: 3/4"=1'-0"

designed: AW JS drawn: AW ES MF reviewed: JZ MM

flatwork details

OUT IN FIELD AND APPROVED BY LANDSCAPE ARCHITECT, MOW PATHS WILL RECEIVE BERMUDA HYDROMULCH





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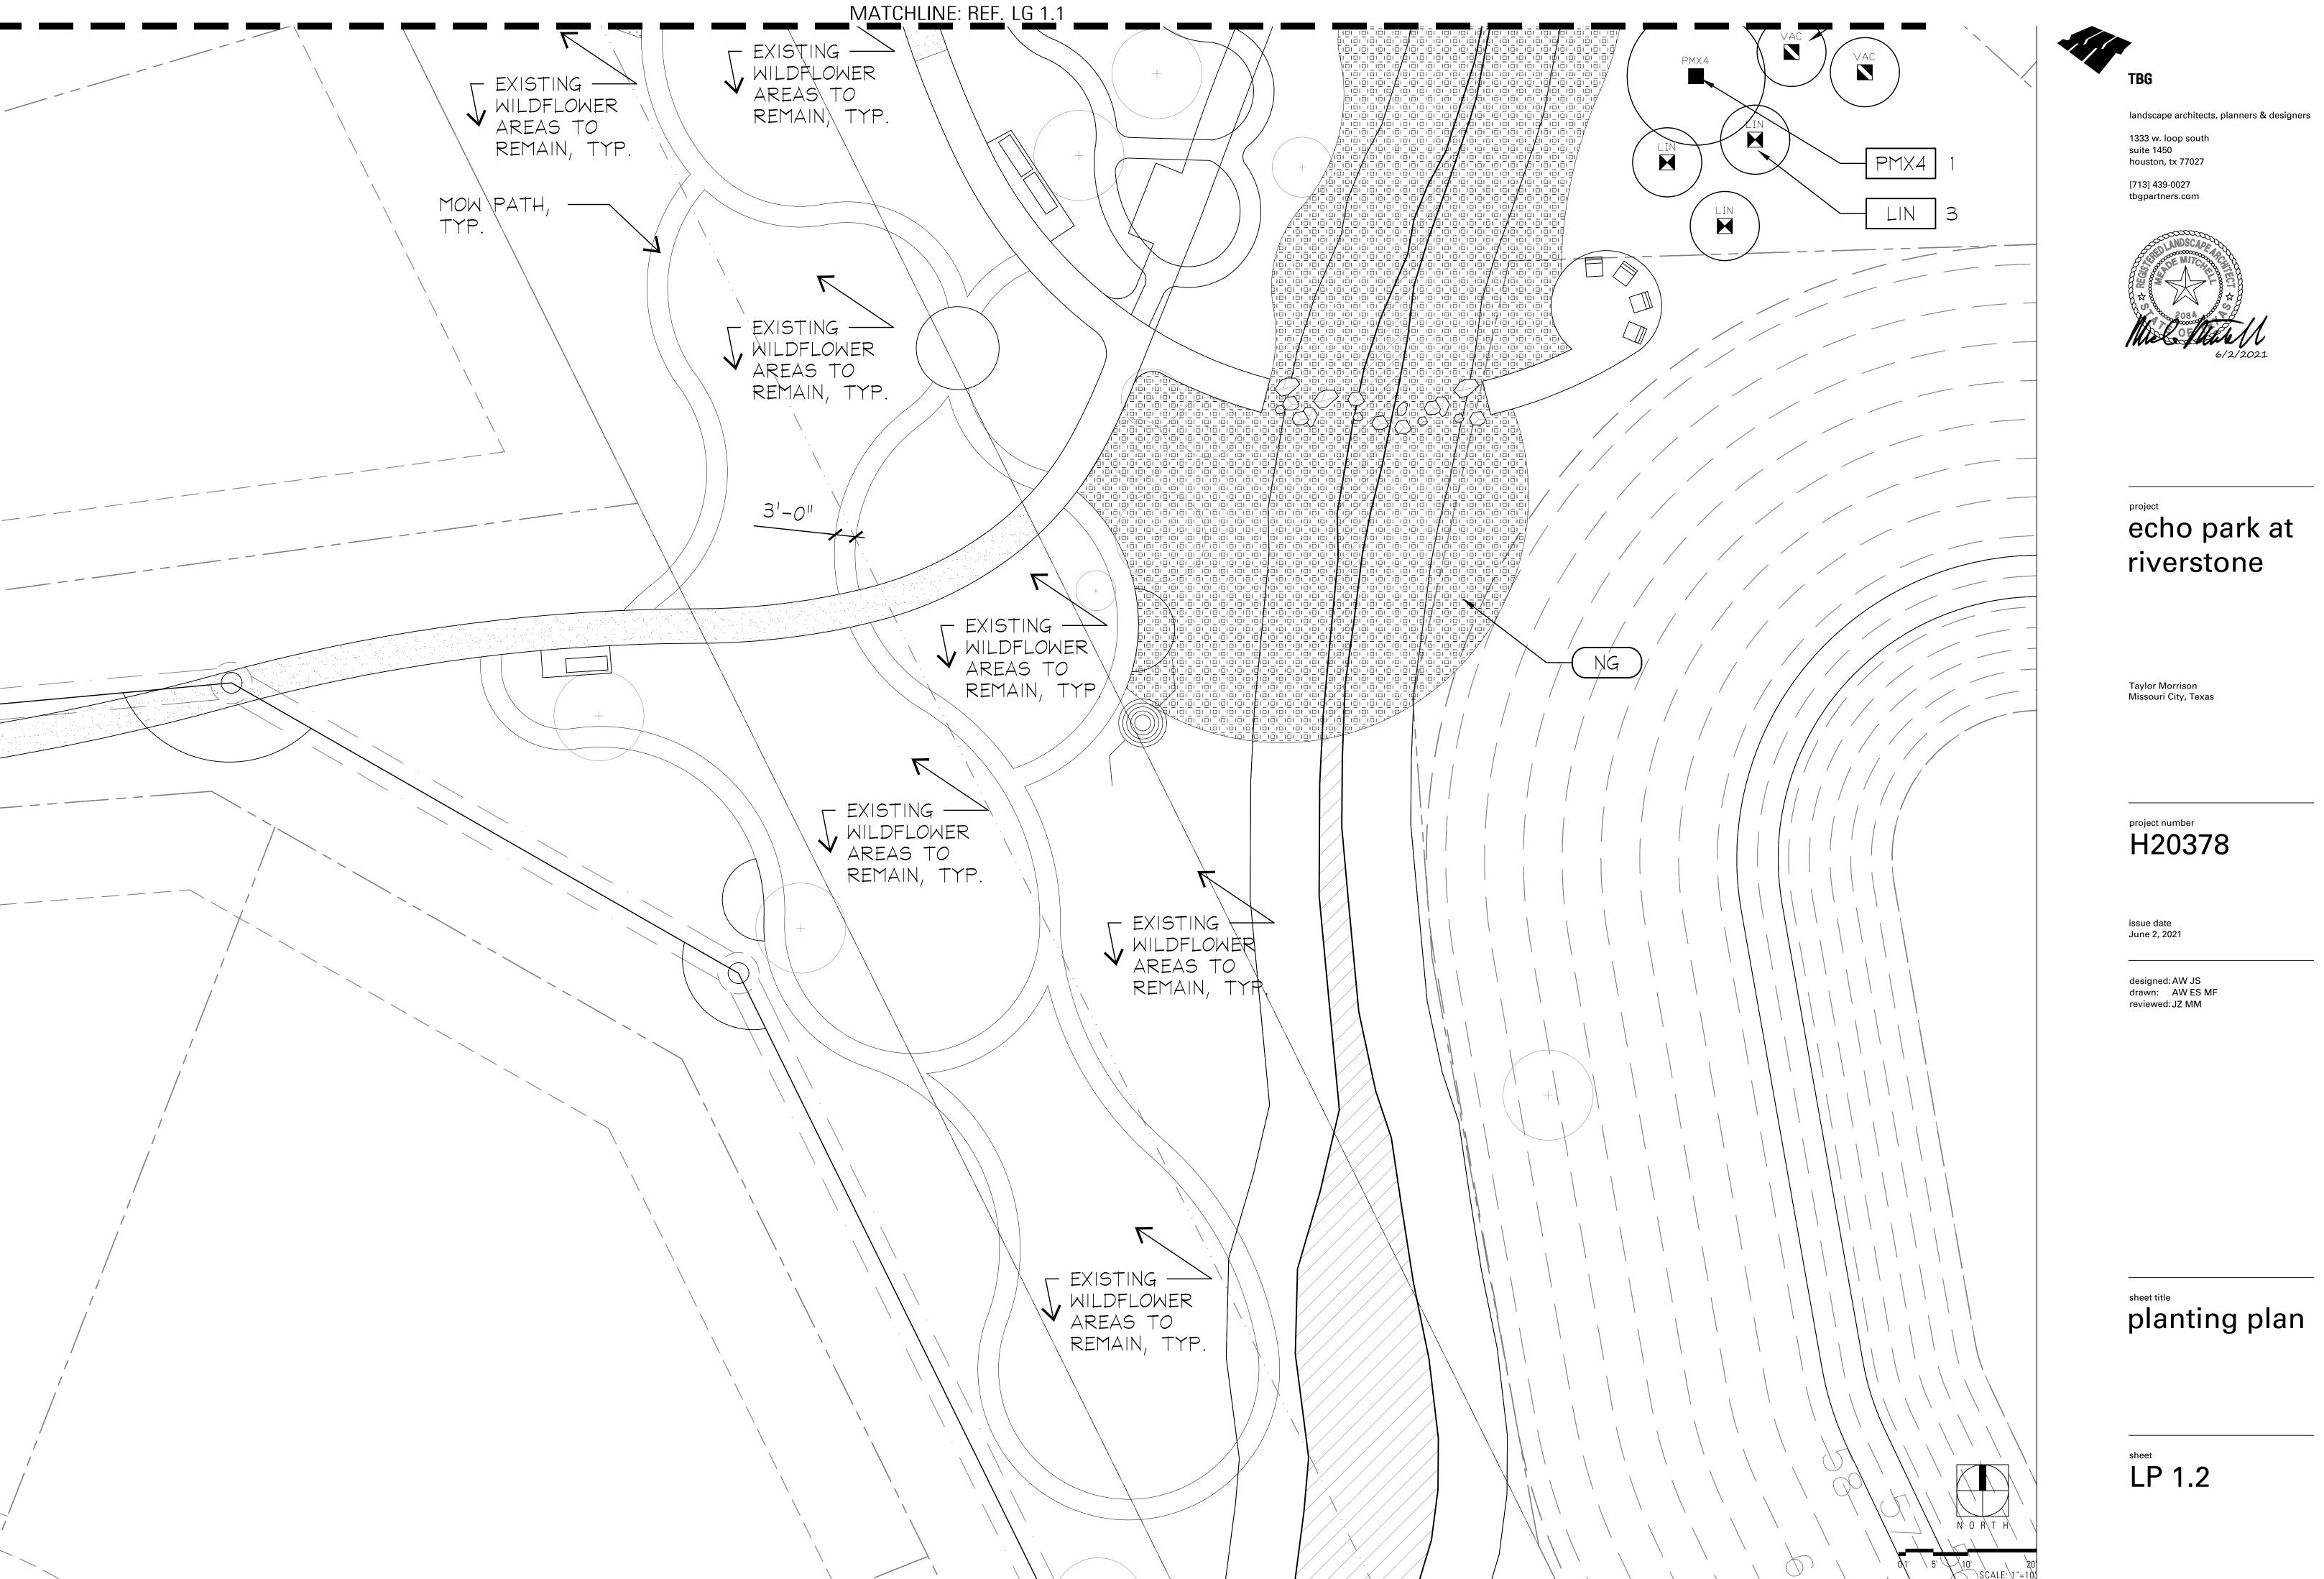
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planting plan

LP 1.1



echo park at

LOCATE AND VERIFY CONDITION OF ALL UTILITIES PRIOR TO ANY EXCAVATION. EXTREME CARE SHALL BE EXERCISED IN EXCAVATING AND WORKING NEAR EXISTING UTILITIES.

- 2.) ANY CONFLICTING INFORMATION SHALL BE BROUGHT TO THE ATTENTION OF THE LANDSCAPE ARCHITECT OR THE LANDSCAPE ARCHITECT AND OWNER SHALL ASSUME THE CONTRACTOR HAS INCORPORATED THE COSTLIEST ITEM.
- 3.) DO NOT WILLFULLY PROCEED WITH CONSTRUCTION AS DESIGNED WHEN UNKNOWN OBSTRUCTIONS AND/OR GRADE DIFFERENCES EXIST THAT MAY HAVE NOT BEEN KNOWN DURING DESIGN. SUCH CONDITIONS SHALL BE IMMEDIATELY BROUGHT TO THE ATTENTION OF THE LANDSCAPE ARCHITECT. THE CONTRACTOR SHALL ASSUME FULL RESPONSIBILITY FOR ALL NECESSARY REVISIONS DUE TO FAILURE TO GIVE SUCH NOTIFICATION.
- 4.) CONTRACTOR SHALL BE RESPONSIBLE FOR ALL COORDINATION WITH HIS SUBCONTRACTORS TO ACCOMPLISH HIS SCOPE OF WORK. CONTRACTOR SHALL COORDINATE CONSTRUCTION WITH OTHER TRADES WORKING ON THE SITE SIMULTANEOUSLY.
- 5.) CONTRACTOR IS RESPONSIBLE FOR LOCATING AND PROTECTING EXISTING IRRIGATION AND LANDSCAPE ON SITE FROM ANY DAMAGE. CONTRACTOR SHALL NOTIFY LANDSCAPE ARCHITECT OF ANY CONFLICTS IMMEDIATELY.
- 6.) CONTRACTOR SHALL NOTIFY OWNER AND LANDSCAPE ARCHITECT 48 HOURS PRIOR TO COMMENCEMENT OF WORK TO COORDINATE PROJECT INSPECTION SCHEDULES.
- 7.) THE CONTRACTOR SHALL BE RESPONSIBLE FOR FIELD VERIFICATION OF EXISTING CONDITIONS, AND SHALL PERFORM FIELD MEASUREMENTS PRIOR TO FABRICATION AND/OR PURCHASE OF ANY MATERIAL AND SHALL CONTACT THE LANDSCAPE ARCHITECT SHOULD EXISTING CONDITIONS BE DIFFERENT FROM THE DESIGN DRAWINGS FOR THIS PROJECT. CONFLICTS ARISING DUE TO LACK OF COORDINATION SHALL BE THE RESPONSIBILITY AND THE EXPENSE OF THE CONTRACTOR.
- 8.) ANY REQUIRED CHANGES TO THE DRAWINGS RESULTING FROM THE ACCEPTANCE OF CONTRACTORS ALTERNATES AND/OR SUBSTITUTIONS ARE THE RESPONSIBILITY OF THE CONTRACTOR AND SHALL BE SUBMITTED TO THE LANDSCAPE ARCHITECT AND THE OWNER FOR APPROVAL.
- 9.) THE CONTRACTOR SHALL COORDINATE STORING OF MATERIALS, PARKING OF VEHICLES AND RESTRICTIONS OF WORK WITH THE OWNER. UNDER NO CIRCUMSTANCES SHALL ANY CONTRACTOR STORE MATERIALS OR PARK VEHICLES UNDER THE CANOPY OF EXISTING TREES.
- 10.) CONTRACTOR SHALL COMPLY WITH ALL APPLICABLE ORDINANCES AND LOCAL CODES. REQUIRED PERMITS SHALL BE OBTAINED BY THE CONTRACTOR.
- 11.) CONTRACTOR SHALL PROVIDE UNIT PRICES BASED ON QUANTITIES ON DOCUMENTS. FIELD CONDITIONS MAY REVISE ACTUAL LOCATION, INCREASING OR DECREASING THE EXTENT OF WORK BID. CHANGES TO THE EXTENT OF WORK RESULTING IN AN INCREASE WILL BE BASED ON UNIT PRICES AND PERFORMED SUBJECT TO APPROVAL OF THE LANDSCAPE ARCHITECT AND THE OWNER IN THE FORM OF A CHANGE ORDER.

UNIT PRICES SHALL NOT ONLY INCLUDE THE COST OF THE ITEM BUT ALSO ALL LABOR, EQUIPMENT, AND OTHER MATERIALS (I.E. BACKFILL MIX, MULCH, ETC.) TO INSTALL THE ITEM COMPLETELY PER SPECIFICATIONS.

- 12.) ALL CONSTRUCTION COVERED BY THESE CONTRACT DOCUMENTS SHALL BE IN CONFORMANCE WITH THE LATEST EDITION OF ALL APPLICABLE CITY AND OSHA CODES AND STANDARDS INCLUDING BUT NOT LIMITED TO THE SOUTHERN BUILDING CODE, ENACTED BY THE INTERNATIONAL CONFERENCE OF BUILDING OFFICIALS, MOST RECENT EDITION, AND AMENDMENTS AS ADOPTED BY THE LOCAL GOVERNMENT.
- 13.) THE CONTRACTOR SHALL PROVIDE ALL LABOR, MATERIALS AND SUPERVISION NECESSARY TO ACCOMPLISH THE WORK AS SHOWN AND NOTED ON THE DRAWINGS UNLESS OTHERWISE SPECIFIED.
- 14.) CONTRACTORS AND SUBCONTRACTORS ARE RESPONSIBLE FOR REMOVAL OF TRASH AND REPAIR OF HAZARDOUS CONDITIONS (TOOLS, OPEN HOLES, ETC.) ON A DAILY BASIS BY END OF WORK DAY.
- 15.) UPON COMPLETION OF CONSTRUCTION AND PRIOR TO FINAL APPROVAL, CONTRACTOR SHALL THOROUGHLY CLEAN UP THE PROJECT SITE OF ALL TRASH, SCRAP, BRICK PIECES, MORTAR AND LITTER, ETC. REPAIR ALL DAMAGE TO FINISH GRADE INCLUDING TAILINGS FROM EXCAVATIONS, WHEEL RUTS, ETC., CAUSED BY CONSTRUCTION.

#### LANDSCAPE NOTES:


- 1.) CONTRACTOR SHALL RECEIVE SITE AT APPROXIMATELY FINAL GRADE, UNLESS OTHERWISE INDICATED. ALL SLOPES SHALL BE SMOOTH AND UNIFORM WITH A MAXIMUM SLOPE OF 3:1 UNLESS OTHERWISE NOTED. TIE INTO EXISTING ADJACENT GRADES SMOOTHLY AND FINE GRADE FOR POSITIVE DRAINAGE AND TO PREVENT WATER FROM STANDING. CUT SWALE TO DIRECT WATER AWAY FROM ALL STRUCTURES AND PROPERTY LINES AND TOWARDS STORM SEWER INLETS. DO NOT DRAIN ANY WATER TOWARDS LOTS / EASEMENTS.
- 2.) TREE PLANTING: REFERENCE SPECIFICATIONS AND DETAILS FOR PLANTING REQUIREMENTS, MATERIALS, AND EXECUTION, INCLUDING STAKING METHODS, PLANT PIT DIMENSIONS, AND BACKFILL REQUIREMENTS. GUY ALL TREES 4" CALIPER AND GREATER, AND STAKE ALL TREES SMALLER THAN 4" CALIPER UNLESS MACHINE MOVED. STAKE ALL MACHINE MOVED TREES WITH THREE (3) METAL T STAKES PER DETAIL.

BACKFILL ALL TREE PITS WITH SPECIFIED PLANTING MIX AND INCORPORATE 5 LBS OF 13-13-13 FERTILIZER PER CU. YD. OF MIX INTO ALL TREE PITS. ALL TREE WATER RETENTION BASINS SHALL RECEIVE MIN. 2" DEEP COMPOSTED HARDWOOD BARK MULCH.

3.) MACHINE MOVE TREES: ALL TREES TO BE MACHINE MOVED DIRECTLY FROM GROWER SHALL BE APPROVED BY LANDSCAPE ARCHITECT PRIOR TO RELOCATION. COORDINATE TREE PRUNING TO BALANCE ROOT LOSS WITH LANDSCAPE ARCHITECT. TREES TO BE MECHANICALLY TRANSPLANTED USING TREE SPADE ALLOWING 9" ROOTBALL PER CALIPER INCH OF TREE.

SET TREE STRAIGHT AND PLUMB, AND FILL ANY AIR SPACES AROUND TREE WITH SPECIFIED SAND OR SANDY LOAM TOPSOIL, WATER IN TO DISPLACE AIR POCKETS. INSTALL 3" HIGH WATER RETENTION BASIN PER SPECIFICATIONS WITH 2" DEEP COMPOSTED BARK MULCH AND WATER THE SPADED TREES THE DAY OF TRANSPLANTING.

- 4.) TREES SHALL BE LOCATED MINIMUM OF 5' 0" FROM WALLS, OVERHEADS, WALKS, EDGING, CURBS AND OTHER TREES WITHIN THE PROJECT. IF CONFLICTS ARISE BETWEEN SIZE OF AREAS AND PLANS, CONTRACTOR TO CONTACT LANDSCAPE ARCHITECT FOR RESOLUTION. FAILURE TO MAKE SUCH CONFLICTS KNOWN TO THE LANDSCAPE ARCHITECT MAY RESULT IN CONTRACTOR'S LIABILITY TO RELOCATE MATERIALS.
- 5.) ALL PLANT MATERIALS SHALL BE APPROVED BY THE LANDSCAPE ARCHITECT PRIOR TO INSTALLATION. FINAL LOCATION OF ALL PLANT MATERIAL SHALL BE SUBJECT TO THE APPROVAL OF THE LANDSCAPE ARCHITECT. CONTRACTOR SHALL NOTIFY LANDSCAPE ARCHITECT 48 HOURS PRIOR TO COMMENCEMENT OF WORK TO COORDINATE PROJECT INSPECTION SCHEDULES.
- 6.) LAWN INSTALLATION: PRIOR TO APPLICATION OF HYDROMULCH, CONTRACTOR SHALL APPLY CONTACT HERBICIDE TO REMOVE ALL EXISTING WEEDS AS NECESSARY, SCARIFY EXISTING SOIL TO SPECIFIED DEPTHS, FINAL DRESS WITH 1/2" TO 1" BANK SAND, AND REMOVE ALL LUMPS, CLODS, TRASH AND STICKS GREATER THAN 1". FINE GRADE TO PROVIDE POSITIVE DRAINAGE AND SMOOTH LAWN AREAS AND CUT SWALES AS NECESSARY TO ENSURE NO PONDING OF WATER. LAY BERMUDA SOD STRIP ALONG BACK OF CURB AND HYDROMULCH BERMUDA PER SPECIFICATIONS WITHIN APPROXIMATE LIMITS SHOWN ON PLANS. FINISHED GRADE OF LAWN AREAS TO BE MINIMUM 1/2" BELOW FINISHED GRADE OF ADJACENT PAVEMENT.
- 7.) CONTRACTOR SHALL APPLY RECOMMENDED PRE-EMERGENT HERBICIDE FOR PREVENTION OF NUTGRASS AND WEEDS UPON ESTABLISHMENT OF BERMUDA LAWN APPROXIMATELY ONE MONTH AFTER HYDROMULCH APPLICATION. FERTILIZE AT SPECIFIED RATES MONTHLY DURING 90 DAY MAINTENANCE PERIOD.

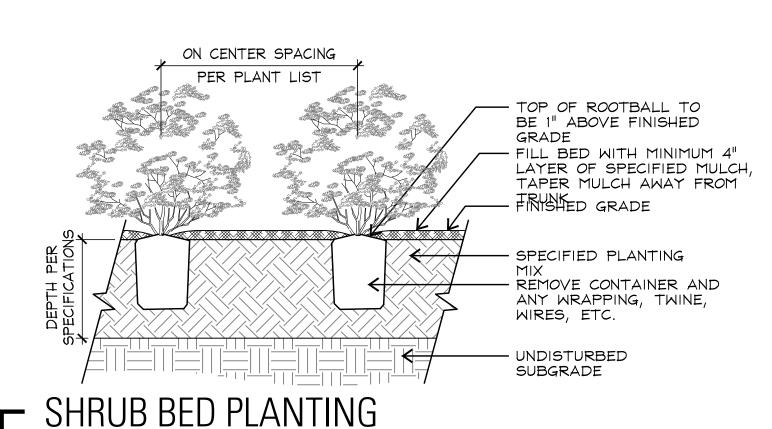

SECTIONS

NOT TO SCALE

NOT TO SCALE

SUBJECTIONS

NOT TO SCALE

PLANT MATERIAL SPACED AT

AUALES BETWEEN ALL ADJACENT SPECIFIED


SEPARATION ZONE BETWEEN ALL ADJACENT SPECIFIED

PLANT MATERIAL SPACED

PLANT MATERIAL SPACED

AT 9"-24" ON CENTER

THIS DETAIL IS DRAWN TO SHOW THE INTENDED PLANTING LAYOUT OF ADJACENT SHRUB BEDS ALONG CURVES. CONTRACTOR TO PLANT ALL PERIMETER OF BED AREAS AS SHOWN AND THEN PLANT THE REMAINDER OF THE BED TRIANGULARLY AT THE SPECIFIED SPACING.

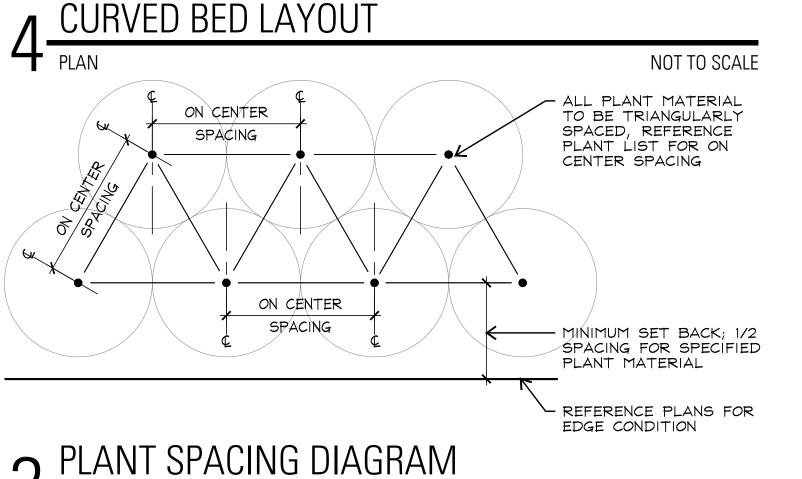

NOT TO SCALE

TOP OF ROOTBALL

TO BE 2" ABOVE

FINISHED GRADE.

DEEPER THAN 2"

TRUNK

MULCH TO BE NO

WITHIN 6" OF TREE

TOP OF ROOTBALL

TO BE 2" ABOVE

FINISHED GRADE.

MULCH TO BE NO

WITHIN 6" OF TREE

DEEPER THAN 2"

SECTION

TRUNK

1'-0"

MINIMUM

1. REFERENCE TECHNICAL SPECIFICATION SECTION

2. TREES LESS THAN 6' HEIGHT = (2) T-POSTS

TREES 6' HEIGHT AND GREATER = (3) T-POSTS

"LANDSCAPE PLANTING" FOR ADDITIONAL REQUIREMENTS

TREE PLANTING - MULTI TRUNK

TREE PLANTING - STANDARD TRUNK

1'-0"

MINIMUM

1. REFERENCE TECHNICAL SPECIFICATION SECTION

2. TREES LESS THAN 4" CALIPER = (2) T-POSTS

TREES 4" CALIPER AND GREATER = (3) T-POSTS

"LANDSCAPE PLANTING" FOR ADDITIONAL REQUIREMENTS

TE

BLACK RUBBER HOSE, ATTACH TO (2) MINIMUM

INNER/LARGER CANES

— 12 GA. MULTI-STRAND WIRE

SUBGRADE. DO NOT DISTURB ROOTBALL.

VERTICAL, AND EVEN

CUT ALL ROPES, WIRES,

AND TOP OF ROOTBALL

- 4" LAYER OF SPECIFIED

FROM ROOTBALL

RETENTION BASIN

FINISHED GRADE

SPECIFIED SOIL

BACKFILL MIX

- BLACK RUBBER HOSE

— 12 GA. MULTI-STRAND WIRE

— 6'-0" GREEN METAL T-POST

T-POSTS TO BE PARALLEL

AND BURLAP FROM TRUNK AND TOP OF ROOTBALL.

REMOVE ALL CONTAINERS

- 4" LAYER OF SPECIFIED

- 5" HIGH EARTHEN WATER

NOT TO SCALE

TO BE INSTALLED 1'-0"
MINIMUM INTO UNDISTURBED

SUBGRADE. DO NOT

VERTICAL, AND EVEN

CUT ALL ROPES, WIRES,

DISTURB ROOTBALL.

FROM ROOTBALL

RETENTION BASIN

FINISHED GRADE

SPECIFIED SOIL

BACKFILL MIX

UNDISTURBED

SUBGRADE

MAXIM TAXABAMA

NOT TO SCALE

UNDISTURBED

SUBGRADE

TAXAKA JAKAKA MASANKA

AND BURLAP FROM TRUNK

REMOVE ALL CONTAINERS

- 5" HIGH EARTHEN WATER

- 6'-0" GREEN METAL T-POST TO BE INSTALLED 1'-0"

MINIMUM INTO UNDISTURBED

T-POSTS TO BE PARALLEL,

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nroicat

# echo park at riverstone

Taylor Morrison Missouri City, Texas

H20378

issue date June 2, 2021

designed: AW JS drawn: AW ES reviewed: JZ MM

eet title

# planting details

LP 2.1

#### **BUTTERFLY GARDEN PLANTING SCHEDULE:**

CONTRACTOR TO SUPPLY PLANT QUANTITY AND NOTIFY LANDCSCAPE ARCHITECT WHEN MATERIAL IS ON SITE. LANDSCAPE ARCHITECT WILL FIELD LAYOUT ALL PLANT MATERIAL.

(25) 3 GAL. BUTTERFLY WEED Asclepias tuberosa

(10) 3 GAL. GREEN MILKWEED Asclepias viridis

(5) 3 GAL. SWAMP MILKWEED Asclepias incarnata

(5) 3 GAL. TEXAS MILKWEED Asclepias texana

(12) 1 GAL. SCARLET BEEBALM Monarda didyma

(9) 3 GAL. TEXAS LANTANA Lantana urticoides

(12) 1 GAL. BLACK EYED SUSAN Rudbeckia hirta (12) 1 GAL. PURPLE CONEFLOWER Echinacea purpurea

(6) 3 GAL. DWARF FIREBUSH Hamelia patens Dwarf

(12) 1 GAL. TURKS CAP Malvaviscus arboreus var. drummondii

(3) 3 GAL. DWARF BARBADOS CHERRY Malpighia punicifolia 'Nana'

OUADE TREE			PLANT LIST		
SHADE TREE	KEY	COMMON NAME	SCIENTIFIC NAME	SIZE	REMARKS
	PMX4	MEXICAN SYCAMORE	PLATANUS MEXICANA	4" CAL. MIN.; 18'	SINGLE STRAIGHT TRUNK; FULL CA
	QV6	LIVE OAK	QUERCUS VIRGINIANA	6" CAL. MIN.; 16' HT. MIN.; 10' SPRD.	SINGLE STRAIGHT TRUNK; FULL CA' CLEAR TRUNK TO 7'-0"; DARK GREEN;SPECIMEN
ORNAMENTA	 L TREE	ES			
GRAPHIC	KEY	COMMON NAME	SCIENTIFIC NAME	SIZE	REMARKS
M	LIN	CRAPE MYRTLE 'NATCHEZ'	LAGERSTROEMIA X FAURIEI 'NATCHEZ'	45 GAL.; 12HT. MIN.; 6' SPRD. MIN.	MULTI-TRUNK; 3-5 CANES; 2" MIN. CANE CAL., FULL CANOPY, DARK GR TREE FORM; CONTAINER GROWN
	VAC	MONTROSE PURPLE VITEX	VITEX AGNUS-CASTUS 'MONTROSE PURPLE'	45 GAL.; 10HT. MIN.; 6' SPRD. MIN.	SPECIMEN, MULTI-TRUNK; 3 CANES MIN.; 2"-2 1/2" MIN. CANE CAL., FUL CANOPY, DARK GREEN, TREE FORM CONTAINER GROWN
SHRUBS, OR	NAMEN	TAL GRASSES, AND	VINES		
GRAPHIC	KEY	COMMON NAME	SCIENTIFIC NAME	SIZE	REMARKS
$\oplus$	BM	WOOLY BUTTERFLY BUSH	BUDDLEJA MARRUBIIFOLIA	3 GAL., 18" HT. \$ SPRD. MIN.	PLANT 30" O.C.
8	CA	AMERICAN BEAUTYBERRY	CALLICARPA AMERICANA	3 GAL.; 18" MIN. HT. \$ SPRD.	PLANT 60" O.C.; FULL; GREEN FOLI,
*	DB	BICOLOR IRIS	DIETES BICOLOR	3 GAL.; 18" HT. \$ SPRD. MIN	PLANT 30" O.C.; FULL, GREEN FOLI YELLOW FLOWER
•	MD	BAMBOO MUHLY	MUHLENBERGIA DUMOSA	3 GAL, 24" HT. \$ SPRD. MIN.	PLANT 30" O.C.
$\Theta$	ME	SOFT CARESS MAHONIA	MAHONIA EURYBRACTEATA 'SOFT CARESS'	3 GAL, 24" HT. \$ SPRD. MIN	PLANT 30" O.C.
*	SL	MEXICAN BUSH SAGE	SALVIA LEUCANTHA	1 GAL., 12" HT. \$ 18" SPRD. MIN.	PLANT 30" O.C.
TURF GRASS	S AND	SEED MIXES			
GRAPHIC	KEY	COMMON NAME	SCIENTIFIC NAME	SIZE	REMARKS
	CDH)	BERMUDA HYDROMULCH	CYNODON DACTYLON	N/A	SEED 2 LBS/1,000 SQ. FT. CONTRACTO FIELD VERIFY QUANTITY
3 81 3112-133	(CDS)	CELEBRATION BERMUDA SOD	CYNODON DACTYLON 'CELEBRATION'		SOLID SOD W/ ANNUAL RYE OVER-SEEDING; FIELD VERIFY QUANTITY
	NG	NATIVE GRASS MIX	SEE MIX SCHEDULE BELOW	N/A	SEE MIX SCHEDULE BELOW
	WF WF	WILDFLOWER OVERSEED (ALL "WF" AREAS TO ALSO RECEIVE "NG" NATIVE GRASS SEED)	SEE MIX SCHEDULE BELOW	N/A	CONTRACTOR SHALL APPLY W/ "WAS INDICATED ON PLANS. REF. SCHEDULE BELOW FOR "WF" MIX.

"NG" NATIVE GRASS MIX:

MIX NO. 1807 "WETLAND FRINGE MIX" BY NATIVE AMERICAN SEED 1 LB PER 2,000 SQUARE FEET

**"WF" WILDFLOWER MIX:** 

MIX NO. 4507 "POLLINATOR ESSENTIALS MIX" BY NATIVE AMERICAN SEED 1 LB PER 2,000 SQUARE FEET



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### echo park at riverstone

Taylor Morrison Missouri City, Texas

H20378

issue date June 2, 2021

> designed: AW JS drawn: AW ES reviewed: JZ MM

# planting details

LP 2.2

BERMUDA AS SPECIFIED

1.) CONTRACTOR TO PROVIDE TYPICAL PHOTO SUBMITTALS OF ALL PLANT MATERIAL TO LANDSCAPE ARCHITECT PRIOR TO INSTALLATION. 2.) CONTRACTOR MUST REPAIR ALL DISTURBED AREAS.

3.) ALL LAWN AREA SEEDED FROM SEPTEMBER 15 - APRIL 15 SHALL BE SEEDED WITH ANNUAL RYE. CONTRACTOR SHALL ERADICATE RYE IN SPRING AND SEED WITH BERMUDA BEFORE PROJECT CLOSEOUT. 4.) ALL LAWN AREA SEEDED FROM APRIL 15 - SEPTEMBER 15, SHALL BE

### DESIGN BUILD IRRIGATION NOTES:

- 1.) IRRIGATION IS DESIGN/BUILD. CONTRACTOR TO UTLIZE EXISTING MAINLINE TO PROVIDE IRRIGATION TO NEW PARK.
- 2.) CONTRACTOR, LANDSCAPE ARCHITECT AND MAINTENANCE CONTRACTOR WILL WALK PRIOR TO START OF CONSTRUCTION TO IDENTIFY ALL EXISTING FACILITIES AND DISCUSS TIE IN.
- 3.) EXISTING WATER METERS AND CONTROLLERS WILL BE USED. NO PERMIT IS REQUIRED FOR THIS SCOPE OF WORK.
- 4.) CONTRACTOR WILL SUBMIT AN ASBUILT OF INSTALLED NEW IRRIGATION.


#### IRRIGATION NOTES

- I. COORDINATE IRRIGATION INSTALLATION WITH PLANTING PLAN AND SITE CONDITIONS TO PROVIDE COMPLETE COVERAGE WITH MINIMUM OVERSPRAY. THE IRRIGATION CONTRACTOR SHALL MAKE MINOR ADJUSTMENTS TO ENSURE PROPER COVERAGE AT NO ADDITIONAL COST TO THE OWNER.
- 2. THE IRRIGATION CONTRACTOR SHALL COMPLY WITH ALL LOCAL AND STATE MANDATED IRRIGATION ORDINANCES AND CODES, AND WILL SECURE ALL REQUIRED PERMITS. L.I.C. SHALL PAY ANY ASSOCIATED FEES UNLESS OTHERWISE NOTED. ALL LOCAL CODES SHALL PREVAIL OVER ANY DISCREPANCIES HEREIN AND SHALL BE ADDRESSED BEFORE ANY CONSTRUCTION BEGINS.
- 3. CONFIRM MINIMUM STATIC WATER PRESSURE OF 68 PSI AT THE HIGHEST ELEVATION OF THE SYSTEM LIMITS, AND MAXIMUM STATIC WATER PRESSURE OF 90 P.S.I. AT THE LOWEST ELEVATION OF THE SYSTEM LIMITS AT LEAST 7 DAYS BEFORE BEGINNING WORK. IF STATIC WATER PRESSURE IS OUTSIDE THE RANGE STATED ABOVE, DO NOT PROCEED UNTIL DIRECTED BY THE LANDSCAPE ARCHITECT.
- 4. LATERAL PIPE SHALL BE INSTALLED AT A MINIMUM DEPTH OF 12 INCHES. MAINLINE PIPE AND WIRES SHALL BE INSTALLED AT A MINIMUM DEPTH OF 18 INCHES. NO MACHINE TRENCHING SHALL BE PERMITTED WITHIN EXISTING TREE ROOT ZONES. WHEN HAND TRENCHING WITHIN EXISTING TREE ROOT ZONES, NO ROOTS LARGER THAN I" DIAMETER SHALL BE CUT.
- 5. UNSLEEVED PIPES MAY BE SHOWN UNDER PAVEMENT FOR GRAPHIC CLARITY ONLY. INSTALL THESE PIPES IN ADJACENT LANDSCAPED AREAS.
- 6. ALL PVC MAINLINE PIPE SHALL BE INSTALLED A MINIMUM OF 48" FROM BACK OF STREET CURBS.
- 7. 24 VOLT VALVE WIRE SHALL BE A MINIMUM #14 GAUGE U.F. APPROVED FOR DIRECT BURIAL, SINGLE CONDUCTOR

  "IRRIGATION WIRE". WIRE SPLICES SHALL INCLUDE DBY CONNECTORS AS MANUFACTURED BY
- 3M COMPANY. ALL FIELD SPLICES SHALL BE LOCATED IN A ROUND VALVE BOX OF SUFFICIENT SIZE TO ALLOW INSPECTION.
- 8. VALVE BOXES SHALL BE INSTALLED FLUSH WITH GRADE, SUPPORTED BY BRICKS IF NEEDED, WITH 3 INCHES
  OF CLEAN PEA GRAVEL LOCATED BELOW THE VALVE. USE 12" x 17" RECTANGULAR VALVE BOXES WITH PURPLE LID
  FOR QUICK COUPLING VALVES, AND 10" ROUND BOXES FOR ELECTRIC VALVES UNLESS NOTED OTHERWISE.
- 9. USE RIGID SCH. 80 PVC SMING JOINT ASSEMBLIES TO CONNECT ALL ROTARY HEADS AND QUICK COUPLERS.
- 10. ALL SPRAY HEADS SHALL BE CONNECTED WITH A 12" MINIMUM LENGTH OF 1/2" FLEX PVC. THE FLEX PVC SHALL BE SOLVENT WELDED TO SCHEDULE 40 PVC FITTINGS WITH WELD-ON #795 SOLVENT AND #P-70 PRIMER.
- II. PROVIDE ONE QUICK COUPLER KEY WITH SWIVEL HOSE ELL FOR EVERY SIX Q.C. VALVES. (MINIMUM ONE SET).
- 12. CONTRACTOR IS TO CONTACT APPROPRIATE AUTHORITIES AND LOCATE ALL UTILITIES PRIOR TO CONSTRUCTION.

#### COORDINATION WITH EXISTING TREES

NO MACHINE TRENCHING SHALL BE PERMITTED WITHIN THE ROOT ZONE OF EXISTING TREES. HAND-DIG ONLY, WITHIN THE ROOT ZONES OF EXISTING TREES. NO ROOTS OVER I" DIAMETER SHALL BE CUT. STAKE ALL PROPOSED TRENCH ROUTES NEAR EXISTING TREES FOR APPROVAL BY THE LANDSCAPE ARCHITECT BEFORE

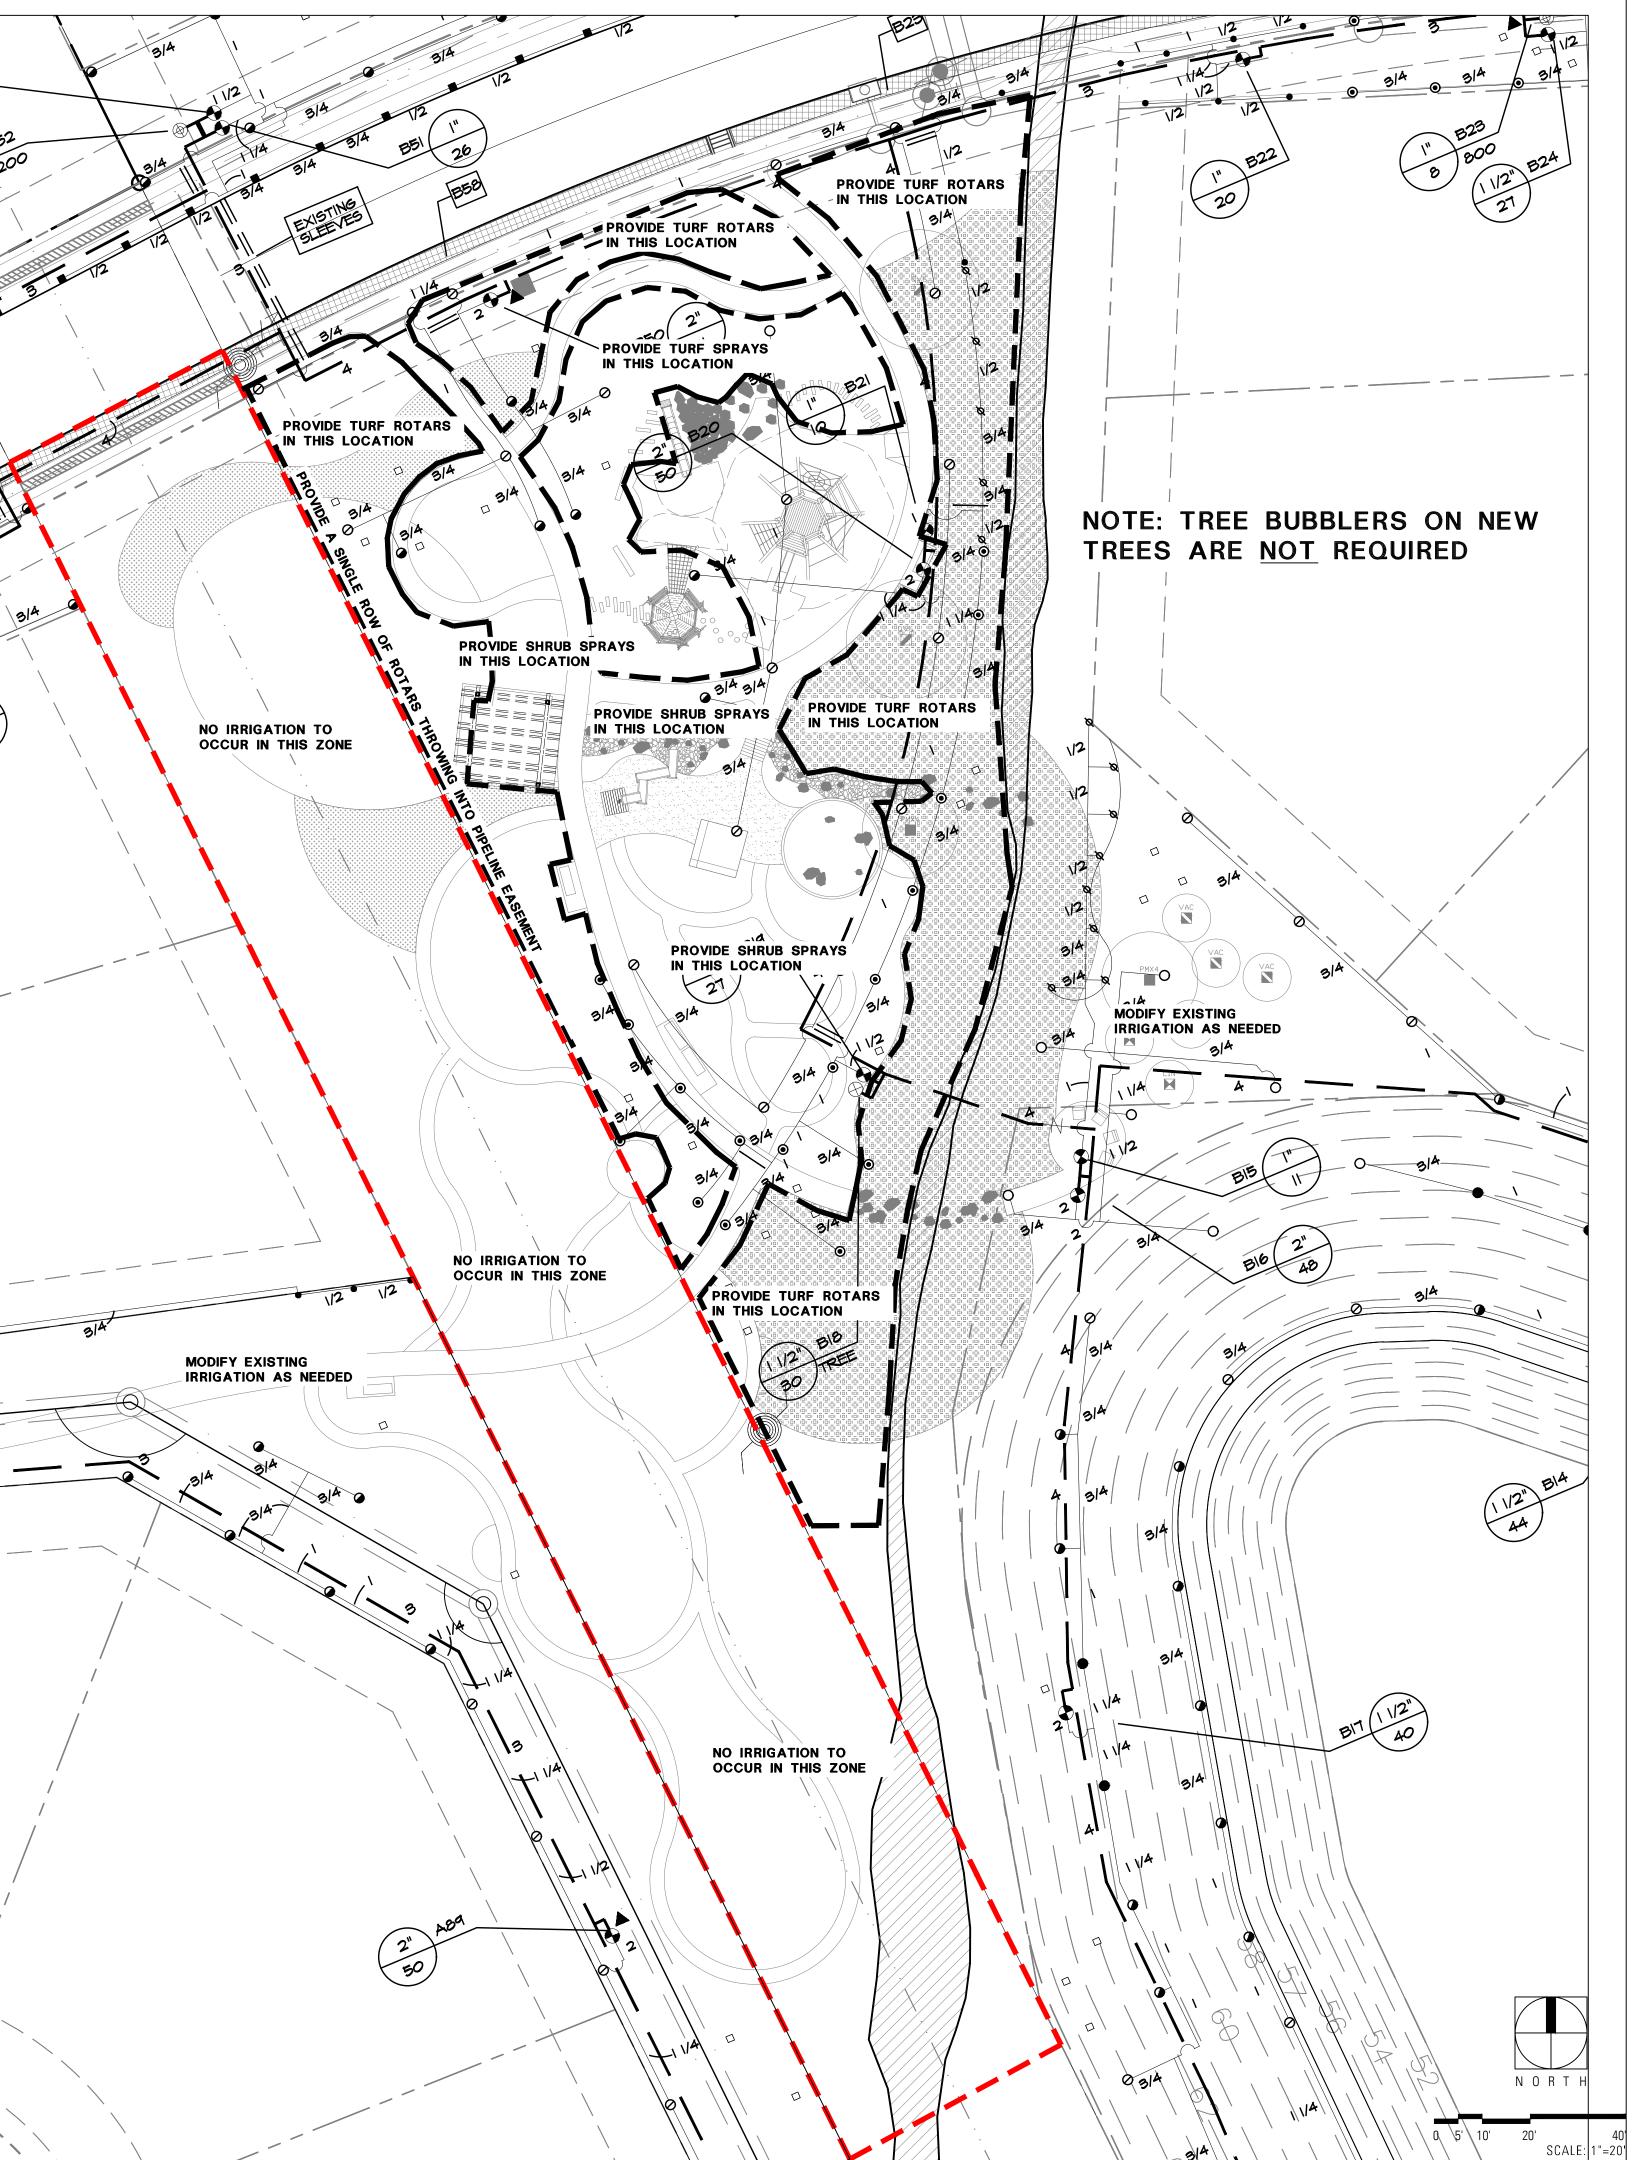



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irrigation exhibit

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